

NOTES:

- 1) TITLE REPORT BY CHICAGO TITLE INSURANCE COMPANY DATED FEBRUARY 15, 2019 AT 8:00 AM, COMMITMENT NUMBER 19-02585WS.
- 2) AREAS COMPUTED BY COORDINATE METHOD.
- 3) PROPERTY SHOWN HEREON IS SUBJECT TO ALL RIGHTS-OF-WAY, EASEMENTS AND RESTRICTIONS OF RECORD.
- 4) ALL DISTANCES SHOWN ON SURVEY ARE HORIZONTAL GROUND DISTANCES UNLESS OTHERWISE NOTED.
- 5) THIS SURVEY DOES NOT REPRESENT A TITLE SEARCH BY THIS FIRM.
- 6) RIGHTS-OF-WAY INFORMATION IS BASED ON DEEDS AND MAPS OF RECORD.
- 7) NC GRID COORDINATES (NAD83) OBTAINED BY USING GPS, PER THE NCVRS NETWORK.
- 8) BASIS OF BEARING SHOWN HEREON IS NC GRID (NAD 83 NSRS 2011).
- 9) VERTICAL DATUM SHOWN HEREON IS NAVD88.
- 10) THE PROPERTY SHOWN HEREON IS LOCATED IN FLOODZONE "ZONE X", AREA OF MINIMAL FLOODING, PER FLOOD INSURANCE RATE MAP 3710987300J, PANEL 9873 EFFECTIVE DATE FEBRUARY 2, 2007.

CHICAGO TITLE INSURANCE COMPANY
COMMITMENT NUMBER: 19-02585WS
COMMITMENT DATE: FEBRUARY 15, 2019 8:00AM
SCHEDULE B, PART II - EXCEPTIONS

1. ANY DEFECT, LIEN, ENCUMBRANCE, ADVERSE CLAIM, OR OTHER MATTER THAT APPEARS FOR THE FIRST TIME IN THE PUBLIC RECORDS OR IS CREATED, ATTACHES, OR IS DISCLOSED BETWEEN THE COMMITMENT DATE AND THE DATE ON WHICH ALL OF THE SCHEDULE B, PART I - REQUIREMENTS ARE MET.
NOT A SURVEY MATTER.
2. TAXES OR ASSESSMENTS FOR THE YEAR 2019, AND SUBSEQUENT YEARS, NOT YET DUE OR PAYABLE.
NOT A SURVEY MATTER.
3. THE CORRECTNESS OF THE SQUARE FOOTAGE/ACREAGE COMPUTATION CONTAINED IN THE DESCRIPTION OF THE LAND IS NOT INSURED.
AFFECTS SUBJECT PROPERTY. PLOTTED AND SHOWN HEREON.
4. RIGHTS OF TENANTS IN POSSESSION, IF ANY, AS TENANTS ONLY, UNDER UNRECORDED LEASES FOR A DURATION OF LESS THAN THREE (3) YEARS.
NOT A SURVEY MATTER.
5. ANY RIGHT, EASEMENT, SETBACK, INTEREST, CLAIM, ENCROACHMENT, ENCUMBRANCE, VIOLATION, VARIATIONS OR OTHER ADVERSE CIRCUMSTANCE AFFECTING THE TITLE DISCLOSED BY PLAT(S) RECORDED IN PLAT BOOK 44, PAGE 14, PLAT BOOK 54, PAGE 168, PLAT BOOK 71, PAGE 91, PLAT BOOK 81, PAGE 88, PLAT BOOK 97, PAGE 32 AND PLAT BOOK 111, PAGE 47.
AFFECTS SUBJECT PROPERTY. PLOTTED AND SHOWN HEREON.
6. MEMORANDUM OF LEASE WITH THE CATO CORPORATION RECORDED IN BOOK 4514, PAGE 176.
AFFECTS SUBJECT PROPERTY. NOT A PLOTTABLE MATTER.
7. MEMORANDUM OF LEASE WITH HIBBETT SPORTING GOODS, INC. RECORDED IN BOOK 5858, PAGE 407 AND AGREEMENT WITH HIBBETT SPORTING GOODS, INC. RECORDED IN BOOK 5879, PAGE 581.
NOT A SURVEY MATTER. NOT A PLOTTABLE MATTER.
8. MEMORANDUM OF LEASE WITH PAPA JOHN'S USA, INC. (THIS APPEARS TO BE EXPIRED BUT THERE ARE RESTRICTED AREAS THAT APPEAR TO AFFECT THE SUBJECT PROPERTY AND THE PAPA JOHN'S APPEARS TO STILL BE IN EXISTENCE AT THE CENTER.)
NO DEED BOOK OF RECORD WITH THIS EXCEPTION.
9. SPECIAL USE PERMIT RECORDED IN BOOK 2801, PAGE 355 AND IRREVOCABLE ASSIGNMENT OF DEVELOPMENT RIGHTS RECORDED IN BOOK 5736, PAGE 237.
AFFECTS SUBJECT PROPERTY. USES, RIGHTS, AND RESTRICTIONS. NO PLOTTABLE MATTERS.
10. EASEMENTS WITH COVENANTS AND RESTRICTIONS AFFECTING LAND RECORDED IN BOOK 2801, PAGE 416 AS AMENDED BY THAT FIRST AMENDMENT TO EASEMENTS WITH COVENANTS AND RESTRICTIONS AFFECTING LAND RECORDED IN BOOK 3725, PAGE 448 AND AFFECTED BY THAT NOTICE OF TRANSFER OF INTERESTS RECORDED IN BOOK 5668, PAGE 467.
AFFECTS SUBJECT PROPERTY. RESTRICTIONS AND COVENANTS. NO PLOTTABLE MATTERS.
11. RESTRICTION AGREEMENT AND GRANT OF EASEMENTS RECORDED IN BOOK 3735, PAGE 472.
AFFECTS SUBJECT PROPERTY. RESTRICTIONS AND USES. NO PLOTTABLE MATTERS.
12. MEMORANDUM OF DEVELOPMENT AGREEMENT RECORDED IN BOOK 3725, PAGE 527 AS AFFECTED BY THAT RELEASE OF MEMORANDUM OF DEVELOPMENT AGREEMENT RECORDED IN BOOK 5668, PAGE 425.
AFFECTS SUBJECT PROPERTY. RELEASE OF MEMORANDUM. NO PLOTTABLE MATTERS.
13. EASEMENTS TO DUKE POWER COMPANY RECORDED IN BOOK 432, PAGE 647 AND BOOK 669, PAGE 92.
AFFECTS SUBJECT PROPERTY. BLANKET TYPE EASEMENT.
14. EASEMENTS TO PIEDMONT ELECTRIC MEMBERSHIP CORPORATION RECORDED IN BOOK 433, PAGE 841 AND BOOK 419, PAGE 510 AS AFFECTED BY THAT PARTIAL RELEASE OF INDENTURE RECORDED IN BOOK 2801, PAGE 359.
DOES NOT AFFECT SUBJECT PROPERTY. EASEMENT RELEASE. NO PLOTTABLE MATTERS.
15. EASEMENT TO CENTRAL TELEPHONE COMPANY RECORDED IN BOOK 480, PAGE 240 AS AFFECTED BY THAT PARTIAL RELEASE OF EASEMENT RECORDED IN BOOK 2801, PAGE 364.
AFFECTS SUBJECT PROPERTY. EASEMENT RELEASE. NO PLOTTABLE MATTERS.
16. EASEMENT TO CENTRAL TELEPHONE COMPANY RECORDED IN BOOK 3291, PAGE 316.
AFFECTS SUBJECT PROPERTY. "10' WIDE CABLE EASEMENT CENTERED OVER EXISTING CABLES WITHIN, ALL OF THE ROADWAY RIGHTS-OF-WAY."
17. SEWER EASEMENT AGREEMENT RECORDED IN BOOK 2801, PAGE 369.
DOES NOT AFFECT SUBJECT PROPERTY. EASEMENT IS LOCATED ON ADJACENT PROPERTIES.
18. EASEMENT AGREEMENT RECORDED IN BOOK 2801, PAGE 378 CREATING A NEW EASEMENT AND TERMINATING THAT EASEMENT RECORDED IN BOOK 423, PAGE 42 AND RE-RECORDED IN BOOK 606, PAGE 281.
AFFECTS SUBJECT PROPERTY. HAMPTON POINTE DRIVE RIGHTS-OF-WAY SHOWN ON THE SURVEY.
19. EASEMENT TO PUBLIC SERVICE COMPANY OF NORTH CAROLINA RECORDED IN BOOK 3177, PAGE 177.
AFFECTS SUBJECT PROPERTY. PLOTTED AND SHOWN ON THE SURVEY.
20. MEMORANDUM OF AGREEMENT RECORDED IN BOOK 2801, PAGE 404 AND RELEASING AGREEMENT IN BOOK 464, PAGE 418.
AFFECTS SUBJECT PROPERTY. NO PLOTTABLE MATTERS.
21. EASEMENT TO THE TOWN OF HILLSBOROUGH RECORDED IN BOOK 423, PAGE 439.
DOES NOT AFFECT SUBJECT PROPERTY. EASEMENT DESCRIBED IS LOCATED ON THE ADJACENT PROPERTIES.
22. ORDINANCE RECORDED IN BOOK 804, PAGE 447.
AFFECTS SUBJECT PROPERTY. ORDINANCE TO LOCATE AREA INCLUDING SUBJECT PROPERTY INTO THE TOWN OF HILLSBOROUGH. NO PLOTTABLE MATTERS.
23. ANY DISCREPANCY, CONFLICT, ACCESS, SHORTAGE IN AREA OR BOUNDARY LINES, ENCROACHMENT, ENCUMBRANCE, VIOLATION, VARIATION, OVERLAP, SETBACK, EASEMENT OR CLAIMS OF EASEMENT, RIPARIAN RIGHT, AND TITLE TO LAND WITHIN ROADS, WAYS, RAILROADS, WATERCOURSES, BURIAL GROUNDS, MARSHES, DREDGED OR FILLED AREAS OR LAND BELOW THE MEAN HIGHWATER MARK OR WITHIN THE BOUNDS OF ANY ADJOINING BODY OF WATER, OR OTHER ADVERSE CIRCUMSTANCE AFFECTING THE TITLE THAT WOULD BE DISCLOSED BY A CURRENT INSPECTION AND ACCURATE AND COMPLETE LAND SURVEY OF THE LAND.
THE ABOVE INFORMATION IS SHOWN ON THE SURVEY, AS PLOTTABLE AND APPLICABLE.

LOT 2D
HAMPTON POINTE
SUBDIVISION
PB 113, PG 27

N/F
DT RETAIL PROPERTIES LLC
PIN: 9873-59-6043
DB 5834, PG 92

LOT 2D
HAMPTON POINTE
SUBDIVISION
PB 113, PG 27

N/F
DT RETAIL PROPERTIES LLC
PIN: 9873-59-6043
DB 5834, PG 92

LOT 2A
HAMPTON POINTE
SUBDIVISION
PB 97, PG 32



N/F
HD DEVELOPMENT OF
MARYLAND INC
PIN: 9873-68-0800
DB 4152, PG 1

LOT 2A
HAMPTON POINTE
SUBDIVISION
PB 97, PG 32

N/F
HD DEVELOPMENT OF
MARYLAND INC
PIN: 9873-68-0800
DB 4152, PG 1

LEGEND

	123	EXISTING CONTOUR		APPROX. LOC. UNDERGROUND GAS LINE PER UTILITY MARKOUT
		LINE SURVEYED		APPROX. LOC. UNDERGROUND WATER LINE PER UTILITY MARKOUT
		LINE NOT SURVEYED		APPROX. LOC. UNDERGROUND ELEC. LINE PER UTILITY MARKOUT
	x 123.45	EXISTING SPOT ELEVATION		MNF MAG NAIL FOUND
		WATER METER		IPF IRON PIPE FOUND
		AREA LIGHT		IPS IRON PIPE SET
		CLEAN OUT		PKS PK NAIL SET
		STORM DRAINAGE GRATE		

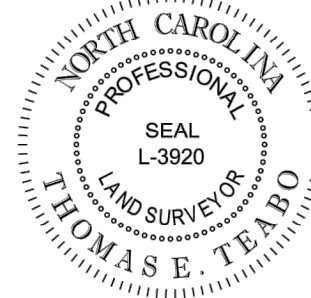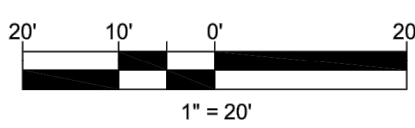

SURVEYOR CERTIFICATION

I, THOMAS E. TEABO, PLS, HEREBY CERTIFY THAT THIS PLAT WAS DRAWN UNDER MY SUPERVISION FROM AN ACTUAL SURVEY MADE UNDER MY SUPERVISION, FROM DEED AND MAP REFERENCES AS NOTED ON SAID MAP; THAT THE BOUNDARIES NOT SURVEYED ARE CLEARLY INDICATED AS DRAWN FROM INFORMATION FROM DEED AND MAP REFERENCES AS NOTED ON SAID MAP.

THAT THE RATIO OF PRECISION OR POSITIONAL ACCURACY OF THE SURVEY AS CALCULATED IS 1:10,000, THAT THE BOUNDARIES NOT SURVEYED ARE SHOWN AS BROKEN LINES PLOTTED FROM INFORMATION OF RECORD; THAT THIS MAP WAS PREPARED IN ACCORDANCE WITH TITLE 21, CHAPTER 56, NCAC, AS AMENDED.

I HEREBY CERTIFY THAT THIS MAP WAS DRAWN UNDER MY SUPERVISION FROM AN ACTUAL GPS SURVEY MADE UNDER MY SUPERVISION AND THE FOLLOWING INFORMATION WAS USED TO PERFORM THE SURVEY:

- (1) CLASS OF SURVEY: "CLASS A"
- (2) POSITIONAL ACCURACY: 0.04"
- (3) TYPE OF GPS FIELD PROCEDURE: REAL-TIME KINEMATIC NETWORKS-NCVRS
- (4) DATES OF SURVEY: 07/01/19
- (5) DATUM/EPOCH: NAD 83 (2011) EPOCH 2010.00
- (6) PUBLISHED/FIXED-CONTROL USE: NCVRS
- (7) GEOID MODEL: 2012 (CONUS)
- (8) COMBINED GRID FACTOR(S): 0.999946233
- (9) UNITS: US SURVEY FEET

WITNESS MY ORIGINAL SIGNATURE, LICENSE NUMBER AND AND SEAL THIS 2ND DAY OF AUGUST A.D., 2019.

**PRELIMINARY - NOT FOR RECORDATION,
SALES OR CONVEYANCES**

SURVEYOR NC L-3920

ALTA/NSPS LAND TITLE SURVEY
FOR

MAVIS SOUTHEAST, LLC

PINS: 9873-59-9108

TOWN OF HILLSBOROUGH
HILLSBOROUGH TOWNSHIP
ORANGE COUNTY, NORTH CAROLINA

FILE NO.
NS192039

DATE
08/02/19

FIELD DATE
07/01/19

CREW CHIEF
DL

DRAWN
DET

REVIEWED
TET

APPROVED
TET

SCALE
1" = 20'

DWG. NO.
1 OF 1



BOHLER
ENGINEERING NC, PLLC

4130 PARKLAKE AVENUE
SUITE 130
RALEIGH, NORTH CAROLINA 27612
919.578.9000 • 919.703.2855 FAX
WWW.BOHLENGR.COM

■ PRIVATE NEW YORK ■ BOSTON MA ■ NEW YORK METRO ■ WARREN NJ ■ PHILADELPHIA/DOVER NJ ■ LEHIGH VALLEY PA ■ SOUTH-EASTERN PA
■ BALTIMORE MD ■ SOUTHERN MARYLAND ■ NORTHERN VIRGINIA ■ WASHINGTON DC ■ CENTRAL VIRGINIA ■ CHARLOTTE NC ■ RALEIGH NC


TO: CHICAGO TITLE INSURANCE COMPANY, MAVIS SOUTHEAST, LLC, REDSTONE FUNDING, LLC AND ITS ASSIGNS:

THIS IS TO CERTIFY THAT THIS MAP OR PLAT AND THE SURVEY ON WHICH IT IS BASED WERE MADE IN ACCORDANCE WITH THE 2016 MINIMUM STANDARD DETAIL REQUIREMENTS FOR ALTA/NSPS LAND TITLE SURVEYS, JOINTLY ESTABLISHED AND ADOPTED BY ALTA AND NSPS, AND INCLUDES ITEMS 1, 2, 3, 4, 5, 8, 9, 11 AND 13 OF TABLE A THEREOF. THE FIELD WORK WAS COMPLETED ON JULY 1, 2019.

THOMAS E. TEABO, PLS

NORTH CAROLINA PROFESSIONAL LAND SURVEYOR NO. L-3920

THIS CERTIFICATION IS MADE TO ONLY NAMED PARTIES FOR PURCHASE AND/OR MORTGAGE OF HEREIN DELINEATED PROPERTY BY THE NAMED PURCHASER. NO RESPONSIBILITY OR LIABILITY IS ASSUMED BY SURVEYOR FOR THE USE OF SURVEY FOR ANY OTHER PURPOSE INCLUDING, BUT NOT LIMITED TO, USE OF SURVEY AFFIDAVIT, RESALE OF PROPERTY, OR TO ANY OTHER PERSON NOT LISTED IN CERTIFICATION, EITHER DIRECTLY OR INDIRECTLY.

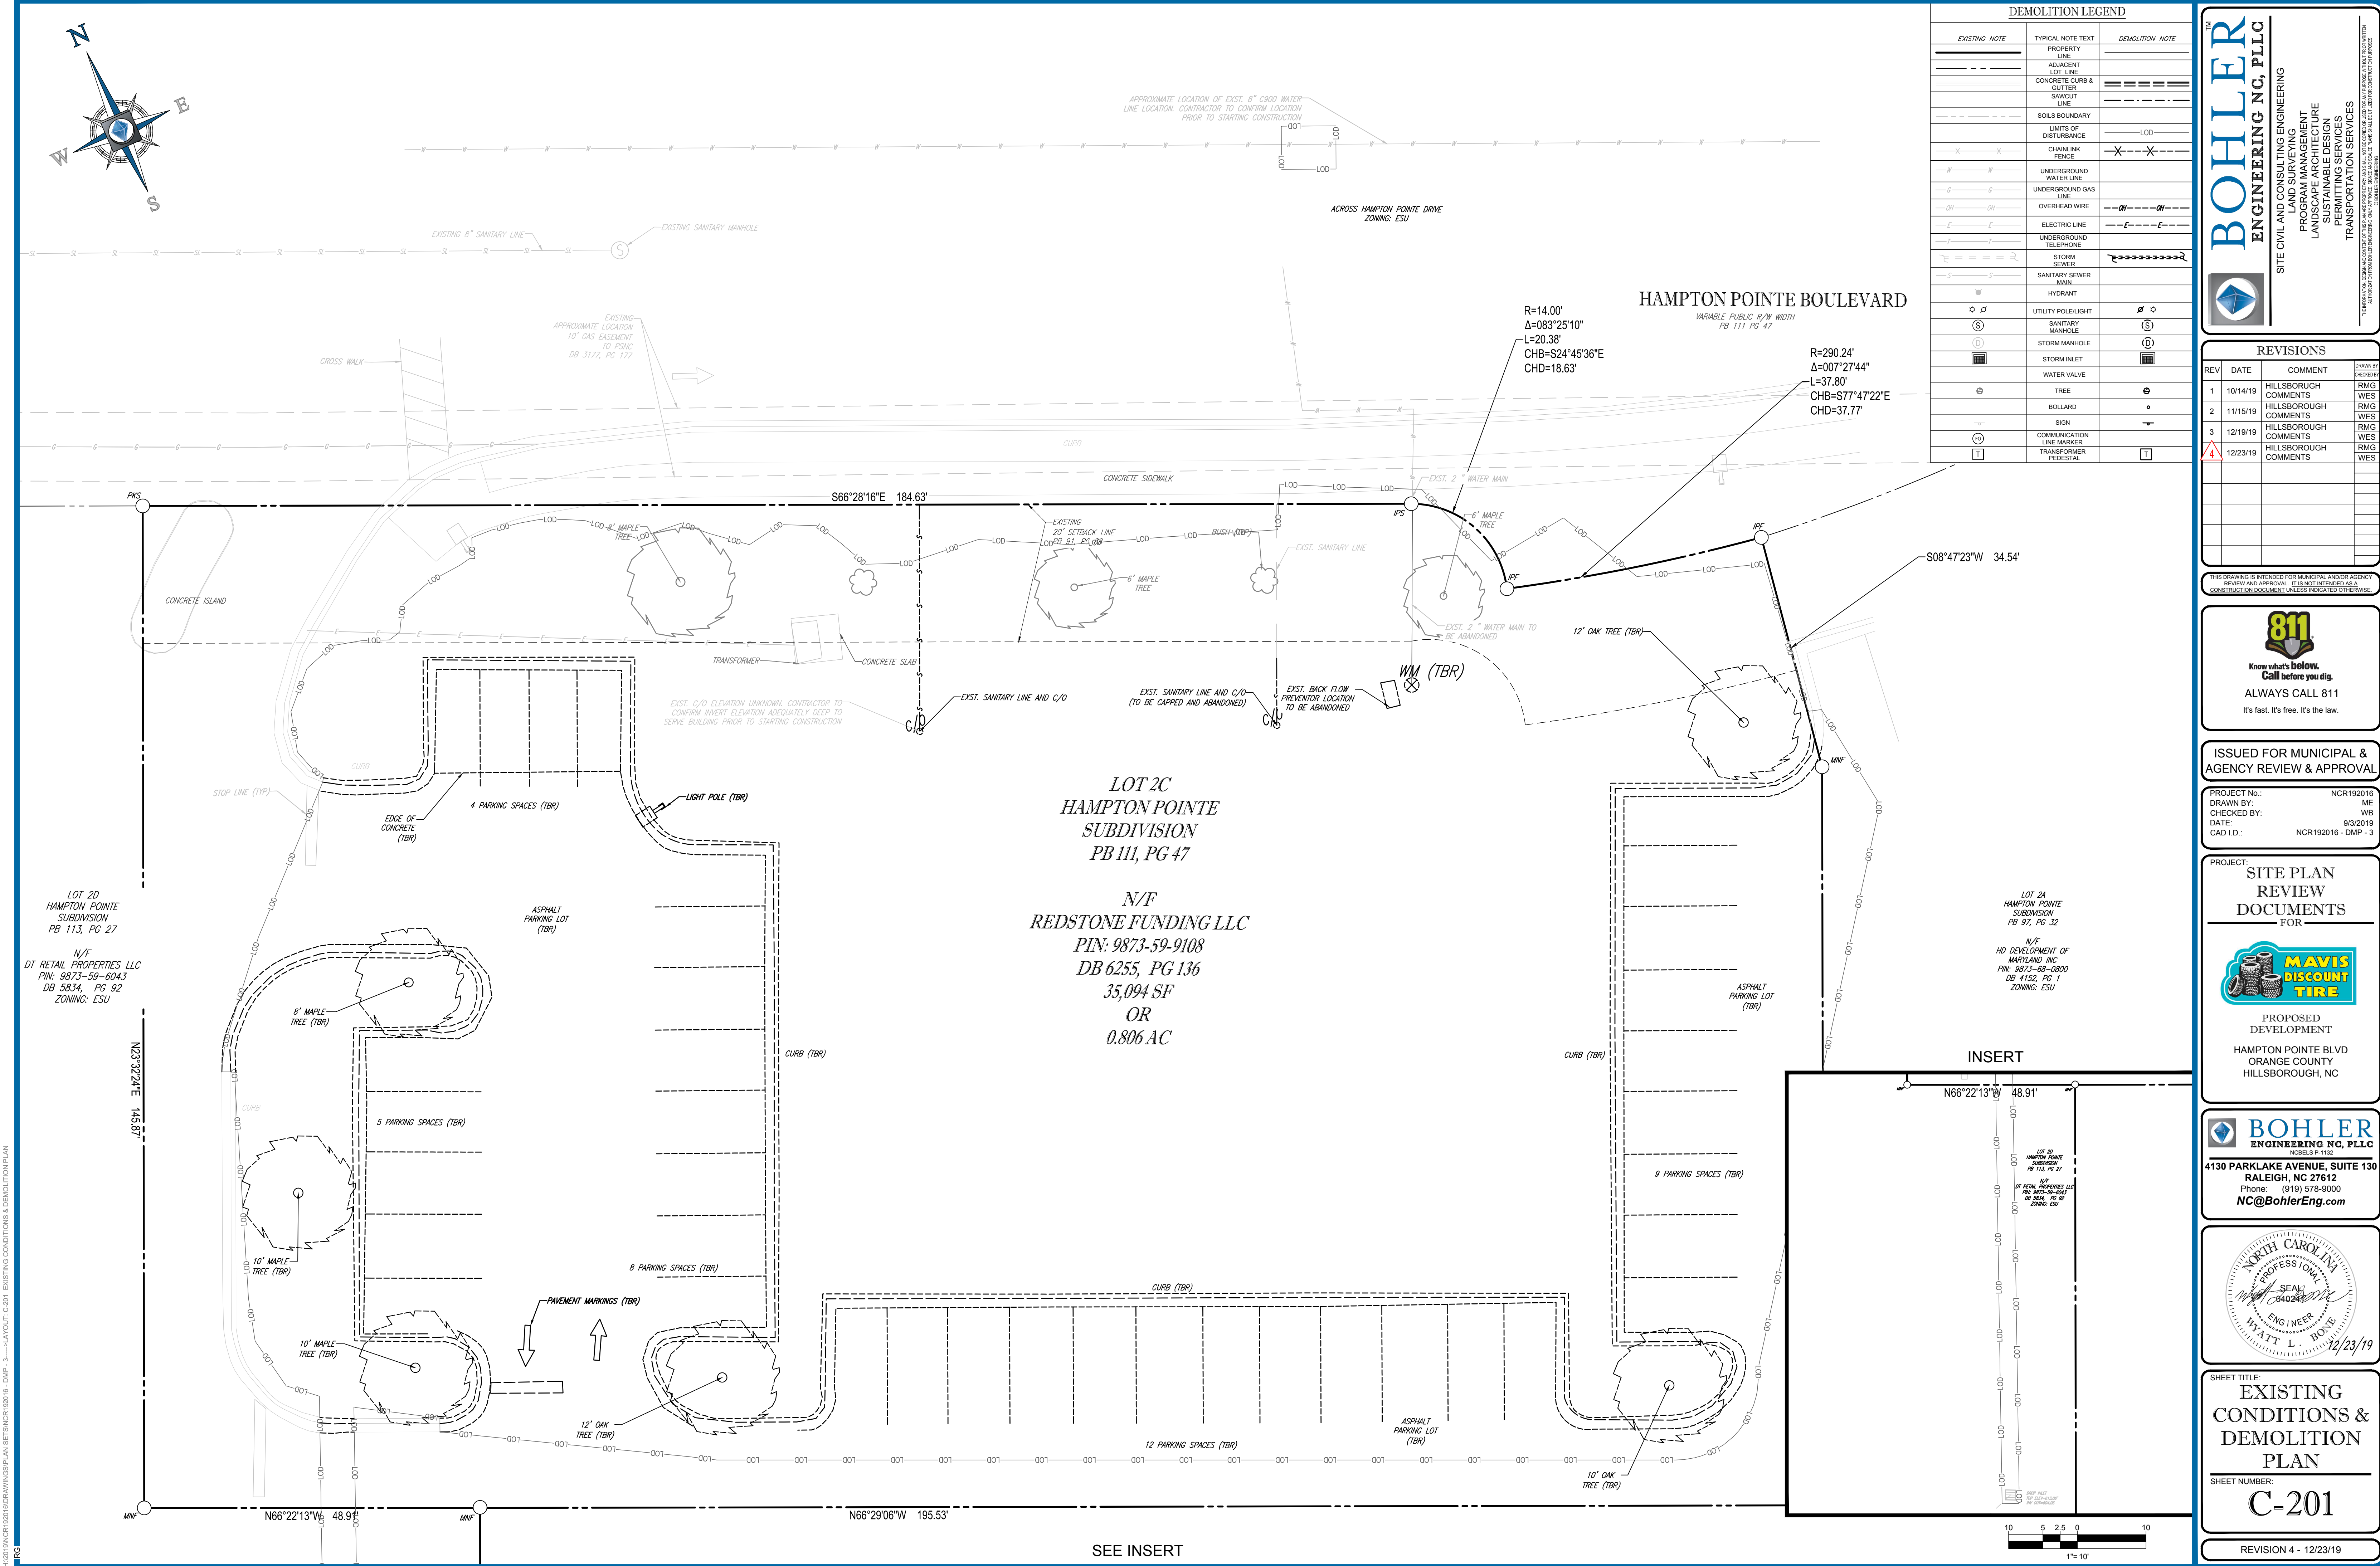

DEMOLITION LEGEND		
EXISTING NOTE	TYPICAL NOTE TEXT	DEMOLITION NOTE
---	PROPERTY LINE	---
---	ADJACENT LOT LINE	---
---	CONCRETE CURB & GUTTER	---
---	SAWCUT LINE	---
---	SOILS BOUNDARY	---
---	LIMITS OF DISTURBANCE	---
---	CHAINLINK FENCE	---
---	UNDERGROUND WATER LINE	---
---	UNDERGROUND GAS LINE	---
---	OVERHEAD WIRE	---
---	ELECTRIC LINE	---
---	UNDERGROUND TELEPHONE	---
---	STORM SEWER	---
---	SANITARY SEWER	---
---	HYDRANT	---
---	UTILITY POLE/LIGHT	---
---	SANITARY MANHOLE	---
---	STORM MANHOLE	---
---	STORM INLET	---
---	WATER VALVE	---
---	TREE	---
---	BOLLARD	---
---	SIGN	---
---	COMMUNICATION LINE MARKER	---
---	TRANSFORMER	---
---	PEDESTAL	---

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SITE CIVIL AND CONSULTING ENGINEERING

PROGRAM MANAGEMENT

LANDSCAPE ARCHITECTURE

SUSTAINABLE DESIGN

PERMITTING SERVICES

TRANSPORTATION SERVICES

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SITE CIVIL AND CONSULTING ENGINEERING

PROGRAM MANAGEMENT

LANDSCAPE ARCHITECTURE

SUSTAINABLE DESIGN

PERMITTING SERVICES

TRANSPORTATION SERVICES

REVISIONS				
REV	DATE	COMMENT	BY	CHECKED BY
1	10/14/19	HILLSBOROUGH COMMENTS	RMG	WES
2	11/15/19	HILLSBOROUGH COMMENTS	RMG	WES
3	12/19/19	HILLSBOROUGH COMMENTS	RMG	WES
4	12/23/19	HILLSBOROUGH COMMENTS	RMG	WES

811

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ISSUED FOR MUNICIPAL & AGENCY REVIEW & APPROVAL

PROJECT No.: NCR192016

DRAWN BY: ME

CHECKED BY: WB

DATE: 9/3/2019

CAD I.D.: NCR192016 - DMP - 3

PROJECT: SITE PLAN REVIEW DOCUMENTS FOR

MAVIS

DISCOUNT

TIRE

PROPOSED DEVELOPMENT

HAMPTON POINTE BLVD

ORANGE COUNTY

HILLSBOROUGH, NC

BOHLER

ENGINEERING NC, PLLC

NCBELS P-1132

4130 PARKLAKE AVENUE, SUITE 130

RALEIGH, NC 27612

Phone: (919) 578-9000

NC@BohlerEng.com

NORTH CAROLINA

PROFESSIONAL

ENGINEER

WATT L. HONE


12/23/19

SHEET TITLE: EXISTING CONDITIONS & DEMOLITION PLAN

SHEET NUMBER: C-201

REVISION 4 - 12/23/19

H:\2019\NCR192016\DRAWINGS\PLAN SETS\NCR192016 - DMP - 3.DWG PRINTED BY: RGALLAGHER 12/23/19 @ 4:02 PM LAST SAVED BY: RGALLAGHER

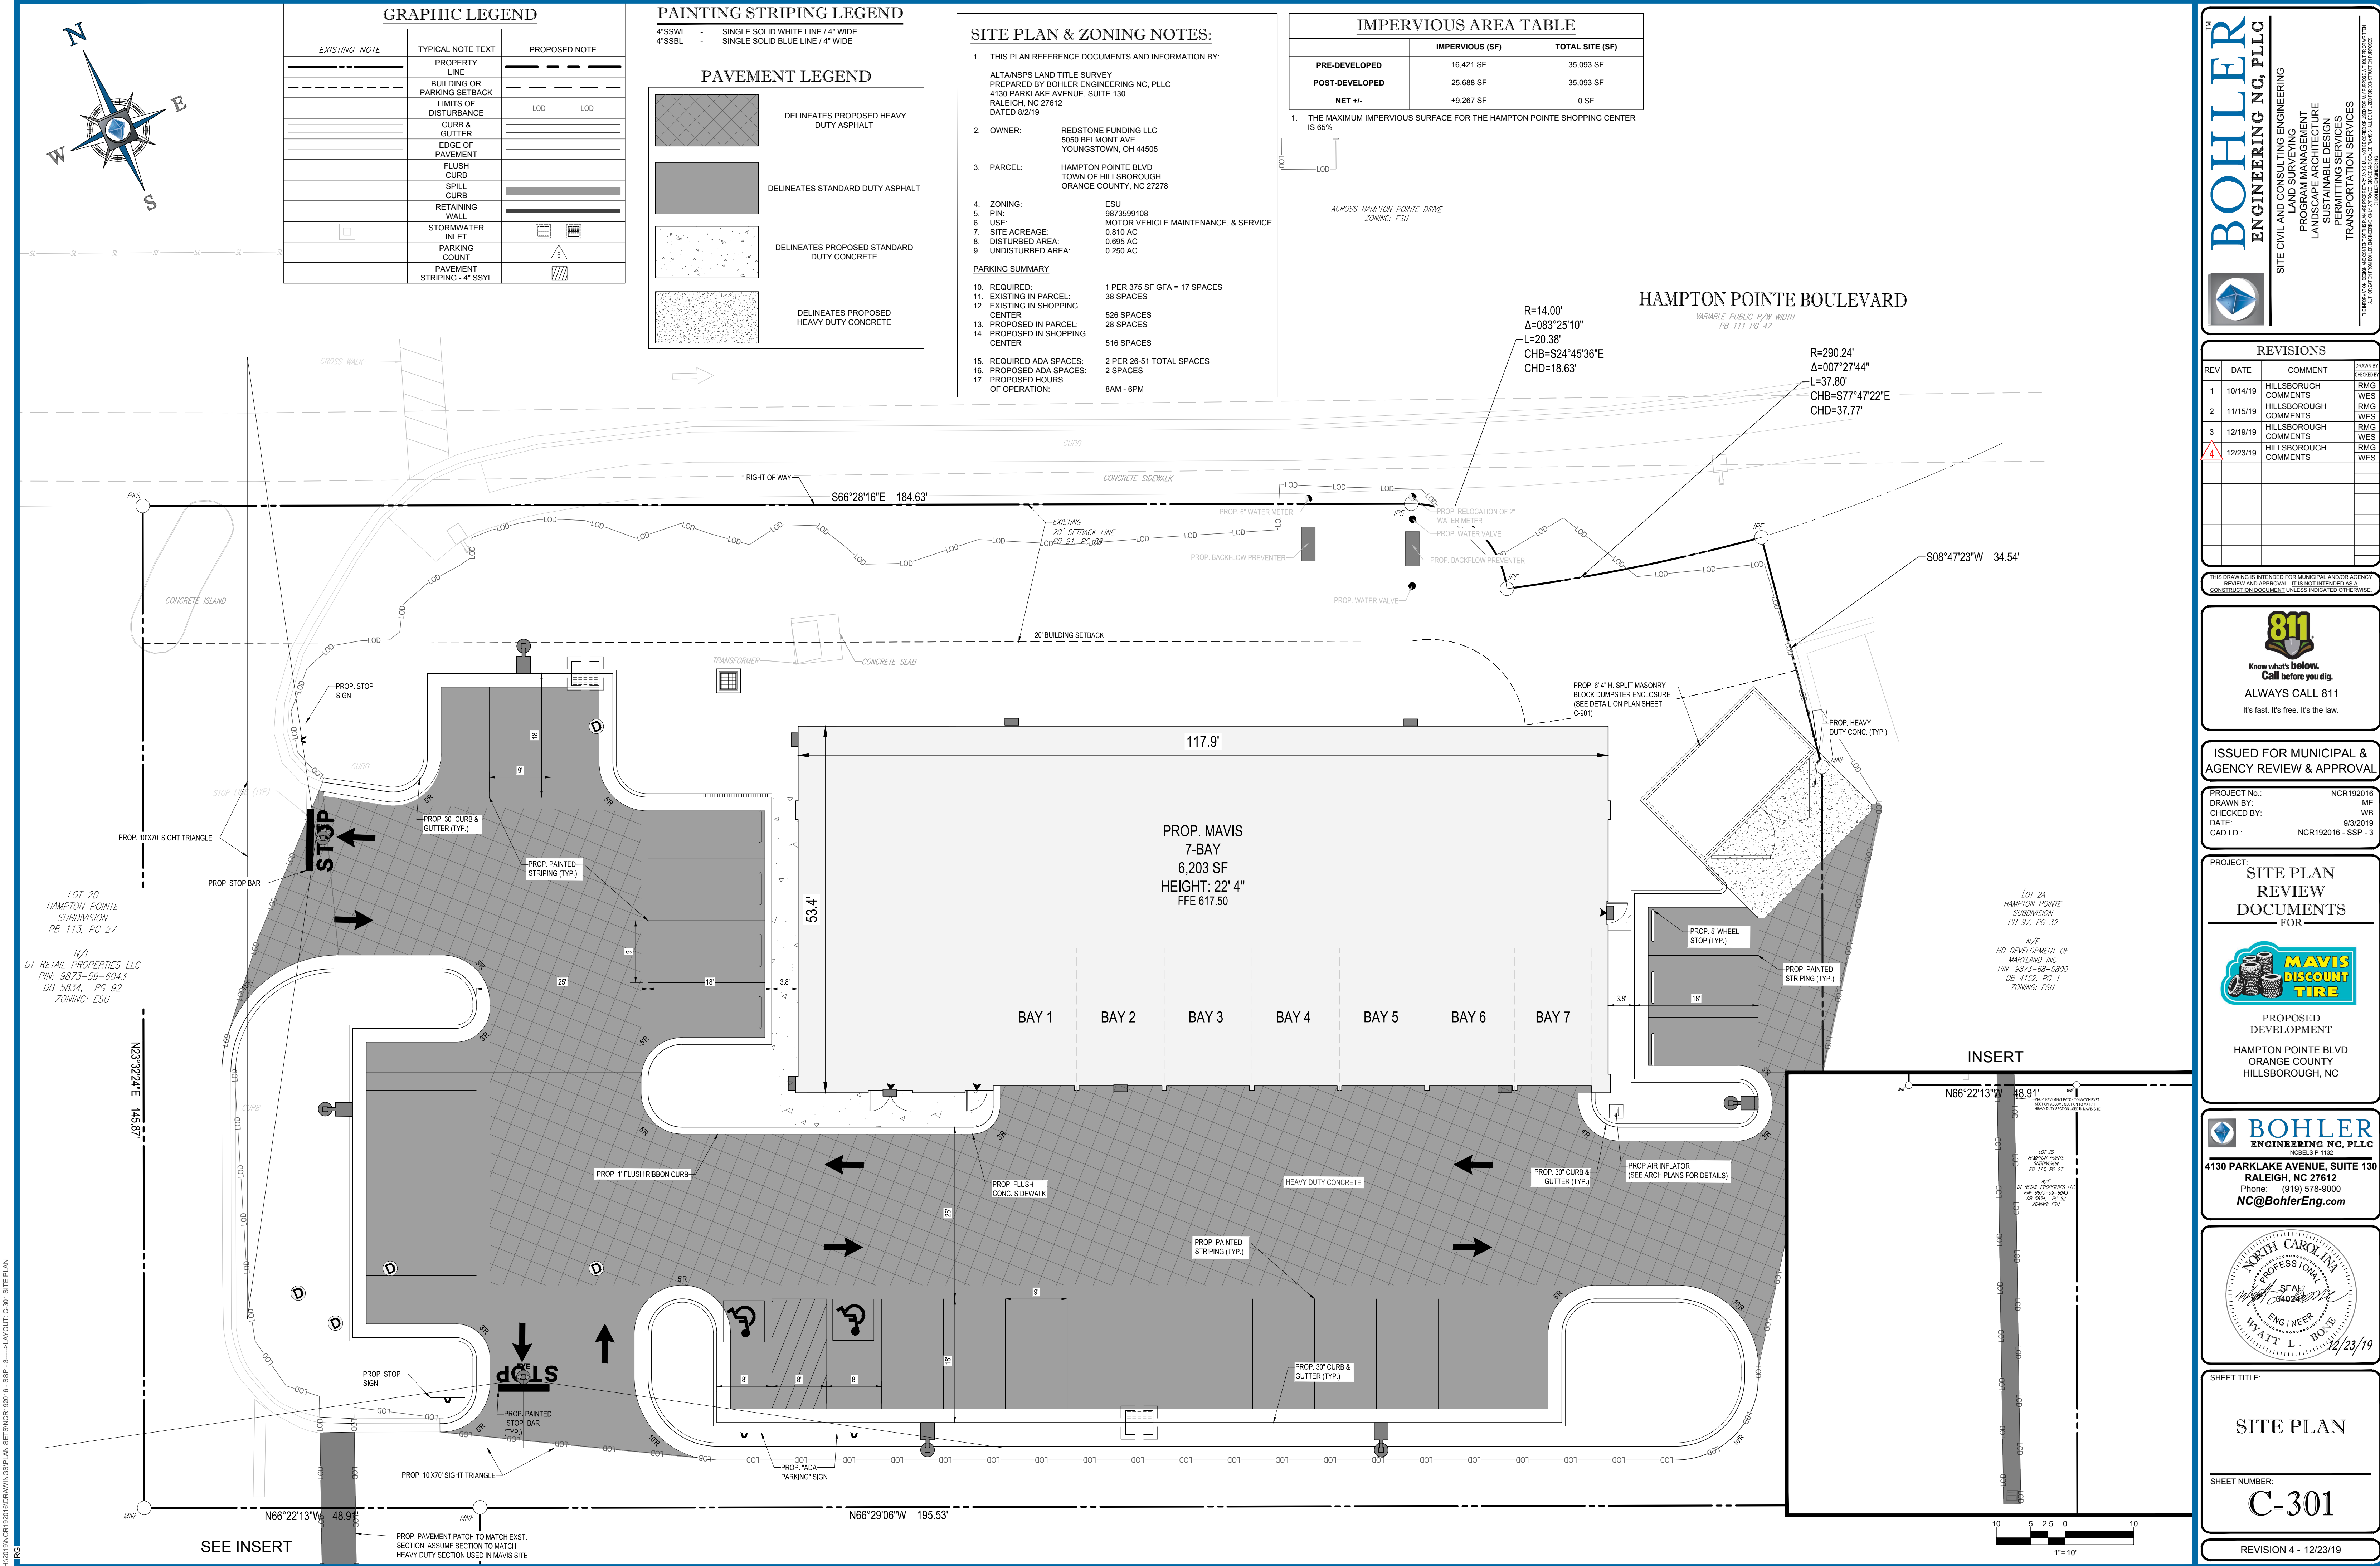

H:\2019\NCR192016\DRAWINGS\PLAN SETS\NCR192016 - SSP - 3 - LAYOUT: C-301 SITE PLAN



GRADING NOTES

1. FOR GRADING LEGEND, REFER TO 'GENERAL NOTES & LEGEND' SHEET.
2. STORM AND SANITARY SEWER PIPE LENGTHS INDICATED ARE NOMINAL AND MEASURED CENTER OF INLET AND/OR MANHOLES STRUCTURE TO CENTER OF STRUCTURE.
3. CURB REVEALS ARE 6" UNLESS OTHERWISE NOTED. FLUSH CURB REVEAL IS 0".
4. IT IS RECOMMENDED THAT THE CONTRACTOR REVIEW THE INTENDED CONSTRUCTION WITH THE LOCAL BUILDING CODE OFFICIAL PRIOR TO COMMENCING WORK.
5. REFER TO DETAIL SHEETS FOR STORM/UTILITY STRUCTURE INFORMATION.
6. REFER TO ADD NOTES ON GENERAL NOTES SHEET.

CONTRACTOR AND ARCHITECT AND DESIGNER TO FOLLOW ECS' RECOMMENDATIONS FOR SOIL PREPARATION AS OUTLINED IN GEOTECH REPORT DATED 24 JANUARY 1, 2019.

SITE CLASS 'D' AS DEFINED IN THE NCSSB 2018, BE USED FOR THE PROPOSED BUILDING.

A CBR VALUE OF 8 TO BE USED IN DESIGN OF THE PROJECT PAVEMENTS.

THE HEAVY DUTY SECTION SHALL BE USED IN ALL DRIVE AISLES AND AREAS WHERE TRASH COLLECTION TRUCKS MAY DRIVE.

THE REFUSE COLLECTOR SHALL BE CONSULTED TO DETERMINE THE SIZE AND THICKNESS OF THE CONCRETE PADS FOR DUMPSITERS.

MIN. SOIL PREPARATIONS FROM HIGH PLASTICITY SOILS (Cl, CH) SHALL BE MAINTAINED BETWEEN FOOTING BEARING (MIN. 2FT), SLAB SUBGRADE (MIN. 3FT), AND PAVEMENT SUBGRADE (MIN. 2FT) TO HELP REDUCE THE POTENTIAL FOR DISTRESS OF CONSTRUCTION AS A RESULT OF VOLUMETRIC CHANGES IN THE SOIL DUE TO VARIATIONS IN ITS MOISTURE CONTENT.

THE GRADING CONTRACTOR SHALL HAVE EQUIPMENT ON SITE DURING EARTHWORK FOR BOTH DRYING AND WETTING FILL SOILS.

CONTRACTOR SHALL NOT USE RUBBER TIRE EQUIPMENT IF SUBGRADE CONDITIONS EXHIBIT ELEVATED MOISTURE CONDITIONS.

THE CONTRACTOR SHOULD USE TRACKED EQUIPMENT TO HELP MINIMIZE THE DEGRADATION OF EXPOSED SUBGRADES.

STORM STRUCTURE SCHEDULE

NAME	TYPE	RIM ELEV. (FT.)	INVERTS
100	EXT. YARD INLET	608.38'	INV IN = 605.98' (12")
101	PROP. 48" DIA MH	615.38'	INV IN = 607.44' (8") INV IN = 611.89' (12") INV OUT = 607.44' (12")
102	PROP. ADS OUTLET STRUCTURE	615.46'	INV OUT = 612.00' (4") INV OUT = 612.00' (12")
103	PROP. ADS INLET MANFOLD	617.15'	INV IN = 613.70' (12")
104	PROP. CURB INLET	617.19'	INV IN = 614.19' (12") INV OUT = 614.09' (12")
105	PROP. YARD INLET	616.90'	INV OUT = 614.40' (12")
106	PROP. ADS INLET MANFOLD	617.14'	INV IN = 612.00' (12")
107	PROP. CURB INLET	616.28'	INV OUT = 615.23' (12")
108	SANDFILTER (INLET)	614.68'	INV IN = 612.00' (4")
109	SANDFILTER (OUTLET)	614.96'	INV OUT = 607.50' (8")

REVISIONS

[illegible]

THIS DRAWING IS INTENDED FOR MUNICIPAL AND/OR AGENCY
REVIEW AND APPROVAL. IT IS NOT INTENDED AS A
CONSTRUCTION DOCUMENT UNLESS INDICATED OTHERWISE.



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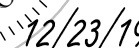
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AGENCY REVIEW & APPROVAL

PROJECT No.:	NCR192016
DRAWN BY:	ME
CHECKED BY:	WB
DATE:	9/3/2019
CAD I.D.:	NCR192016 - GDP - 3

PROJECT: **SITE PLAN
REVIEW
DOCUMENTS**
FOR



HAMPTON POINTE BLVD
ORANGE COUNTY
HILLSBOROUGH, NC




SHEET TITLE:


GRADING
AND
DRAINAGE
PLAN

SHEET NUMBER:
C-401

REVISION 4 - 12/23/19

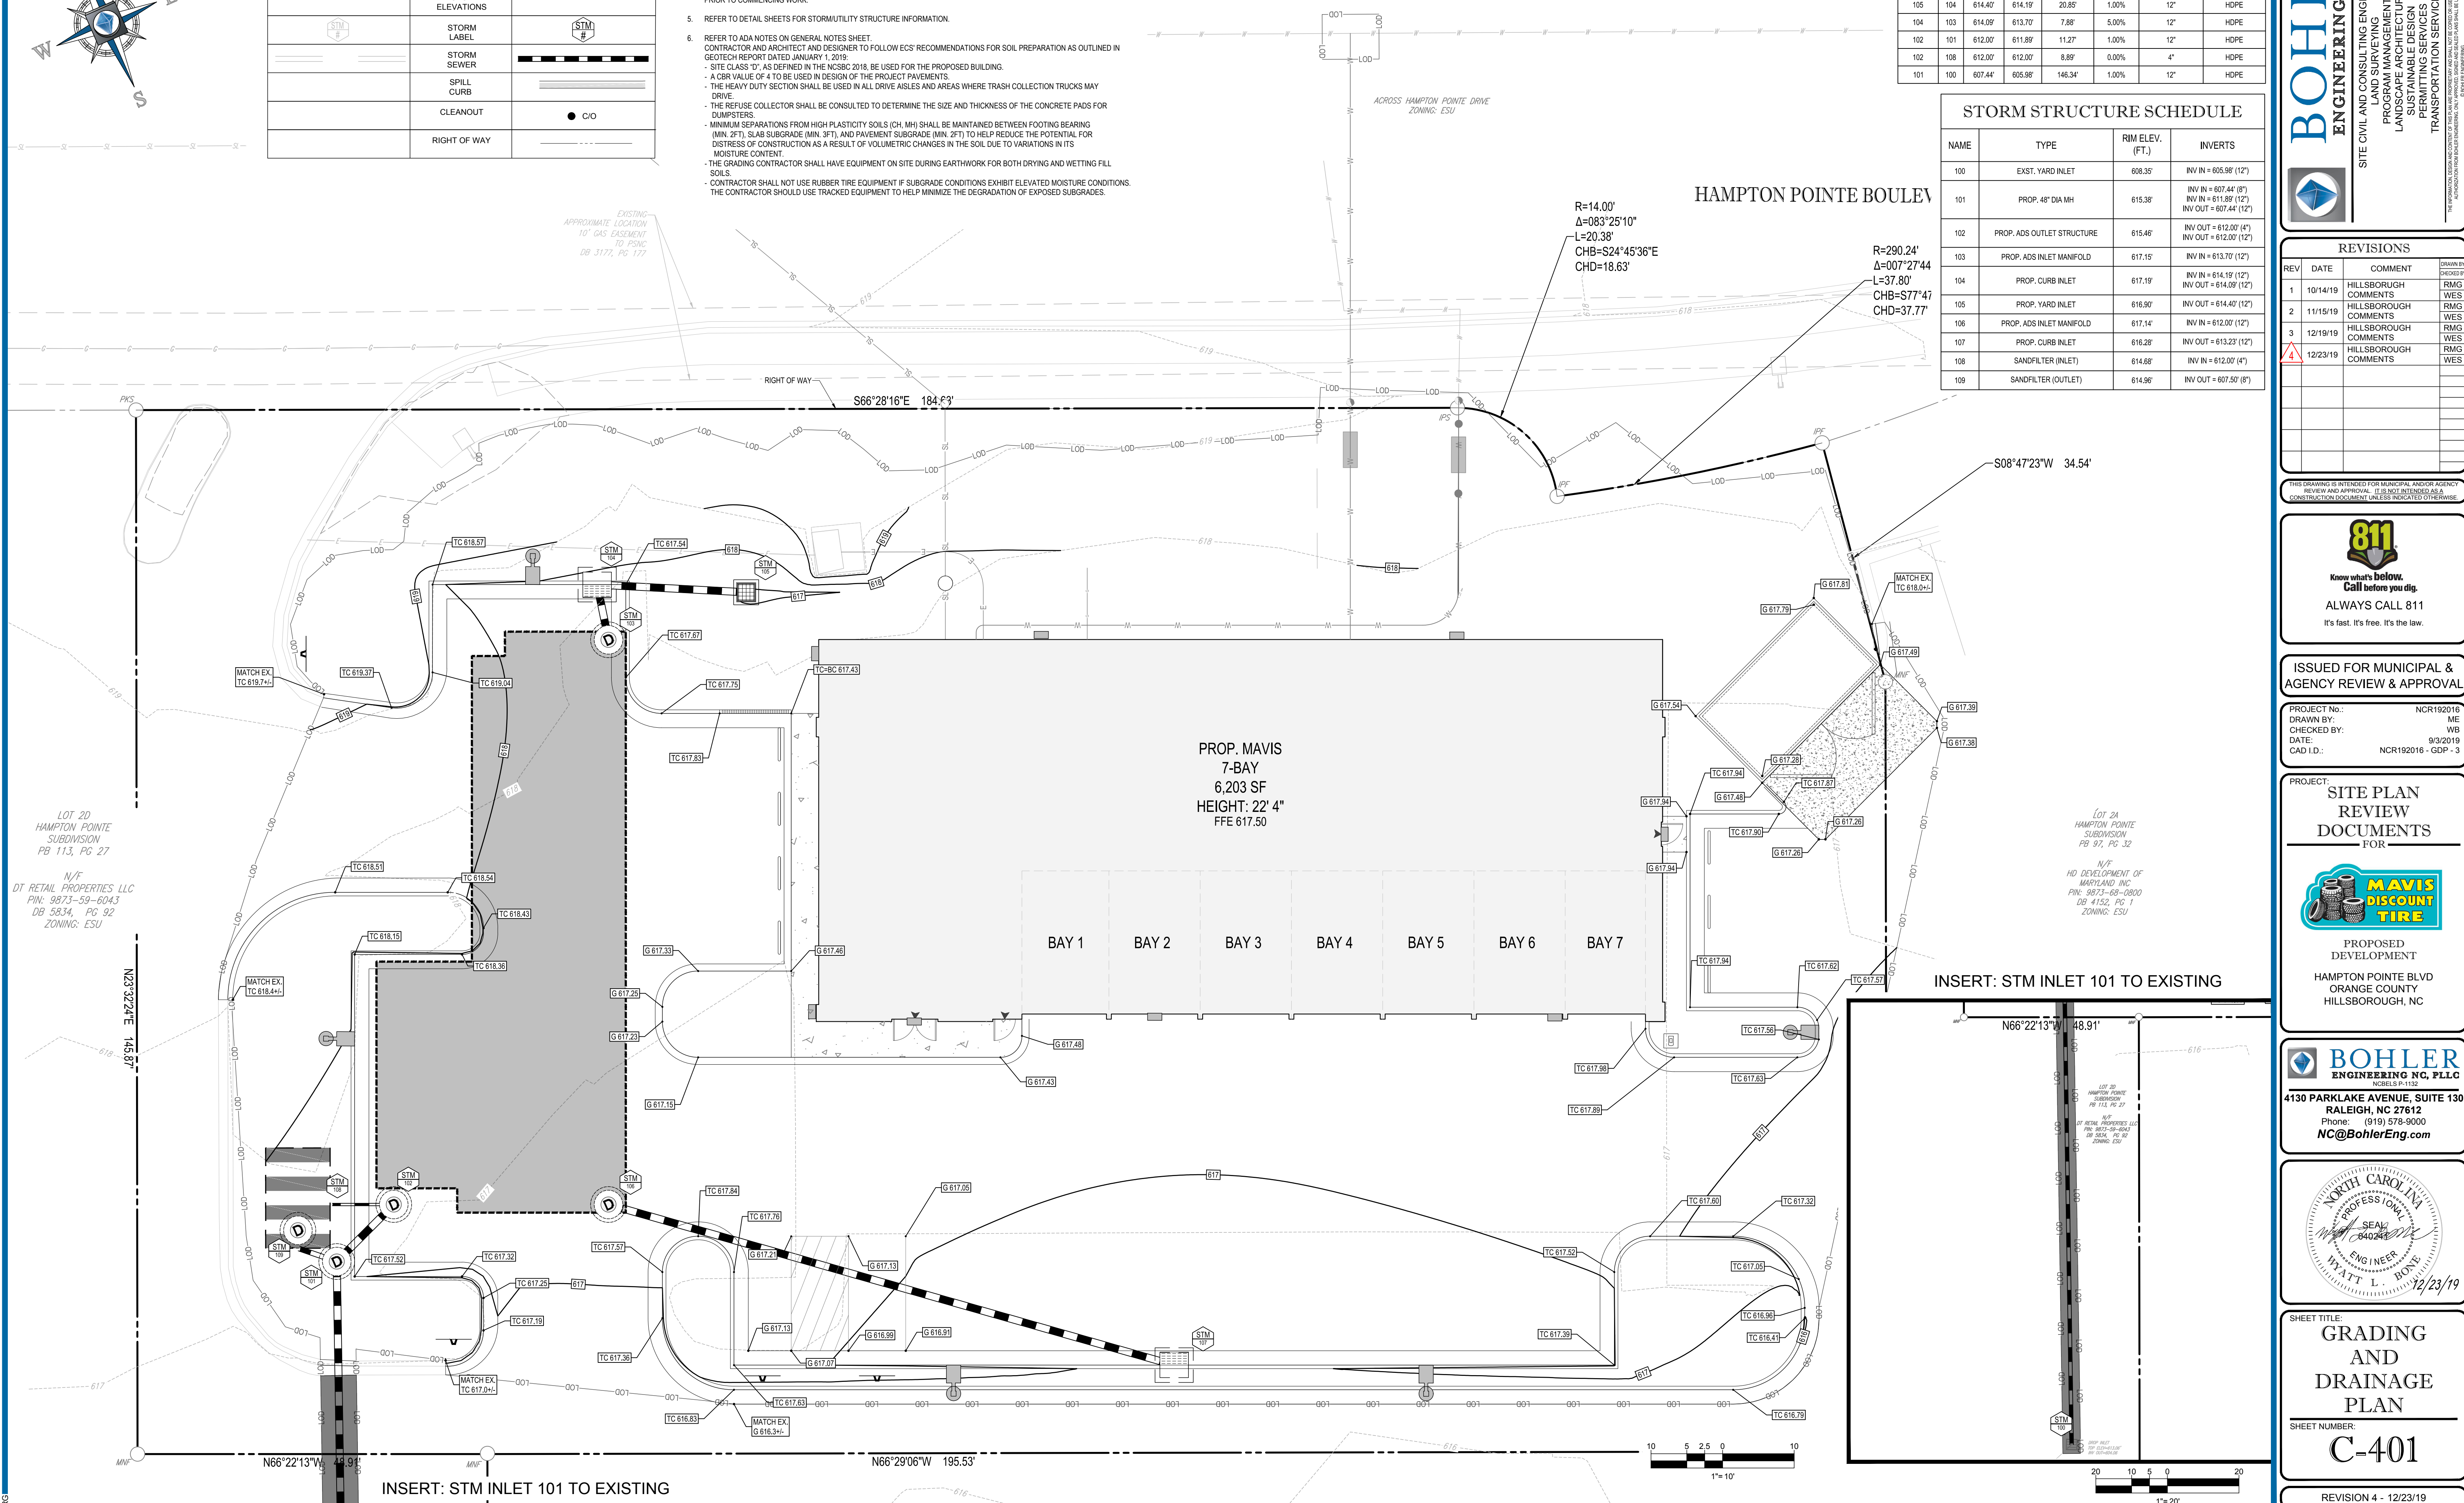

PROPOSED LAYOUT		CONCEPTUAL ELEVATIONS	
76	STORMTECH SC-310 CHAMBERS	MAXIMUM ALLOWABLE GRADE (TOP OF PAVEMENT/UNPAVED):	9.83
20	STORMTECH SC-310 END CAPS	MINIMUM ALLOWABLE GRADE (UNPAVED WITH TRAFFIC):	3.83
6	STONE ABOVE (in)	MINIMUM ALLOWABLE GRADE (UNPAVED NO TRAFFIC):	3.33
6	STONE BELOW (in)	MINIMUM ALLOWABLE GRADE (TOP OF RIGID CONCRETE PAVEMENT):	3.33
40	% STONE VOID	MINIMUM ALLOWABLE GRADE (BASE OF FLEXIBLE PAVEMENT):	3.33
2685	INSTALLED SYSTEM VOLUME (CF)	TOP OF STONE:	2.33
	(PERIMETER STONE INCLUDED)	TOP OF SC-310 CHAMBER:	1.83
	(COVER STONE INCLUDED)	10" x 10" TOP MANIFOLD INVERT:	0.62
	(BASE STONE INCLUDED)	10" x 10" TOP MANIFOLD INVERT:	0.62
2159	SYSTEM AREA (SF)	12" ISOLATOR ROW INVERT:	0.58
232.02	SYSTEM PERIMETER (ft)	12" ISOLATOR ROW INVERT:	0.58
		12" BOTTOM CONNECTION INVERT:	0.50
		BOTTOM OF SC-310 CHAMBER:	0.50
		BOTTOM OF STONE:	0.00

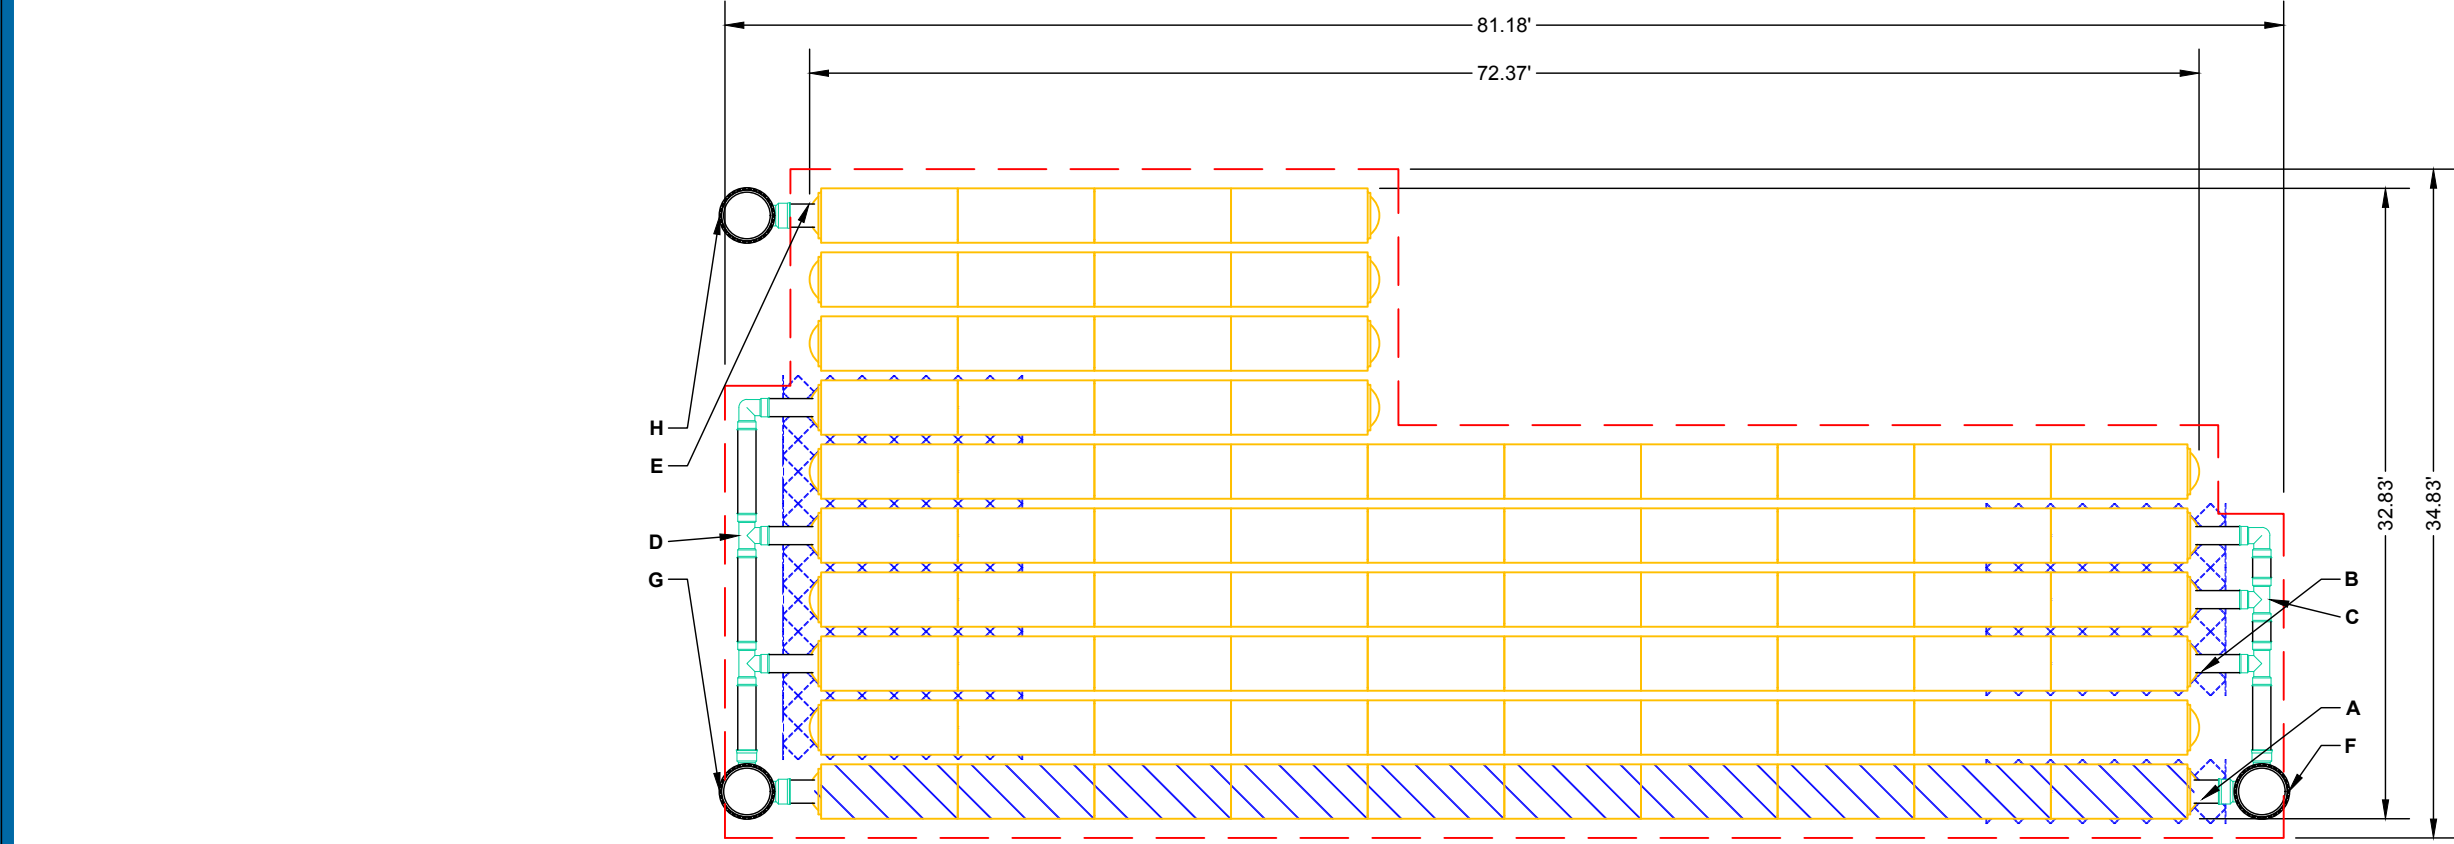

- ISOLATOR ROW
(SEE DETAIL)
- PLACE MINIMUM 12" OF ADS GEOSYNTHETICS 315WTK WOVEN
GEOTEXTILE OVER BEDDING STONE AND UNDERNEATH CHAMBER
FEET FOR SCOUR PROTECTION AT ALL CHAMBER INLET ROWS
- BED LIMITS

NOTES

- MANIFOLD SIZE TO BE DETERMINED BY SITE DESIGN ENGINEER. SEE TECH SHEET #7 FOR MANIFOLD SIZING GUIDANCE.
- DUE TO THE ADAPTATION OF THIS CHAMBER SYSTEM TO SPECIFIC SITE AND DESIGN CONSTRAINTS, IT MAY BE NECESSARY TO CUT AND COUPLE ADDITIONAL PIPE TO STANDARD MANIFOLD COMPONENTS IN THE FIELD.
- THE SITE DESIGN ENGINEER MUST REVIEW ELEVATIONS AND IF NECESSARY ADJUST GRADING TO ENSURE THE CHAMBER COVER REQUIREMENTS ARE MET.
- THIS CHAMBER SYSTEM WAS DESIGNED WITHOUT SITE-SPECIFIC INFORMATION ON SOIL CONDITIONS OR BEARING CAPACITY. THE SITE DESIGN ENGINEER IS RESPONSIBLE FOR DETERMINING THE SUITABILITY OF THE SOIL AND PROVIDING THE BEARING CAPACITY OF THE INSITU SOILS. THE BASE STONE DEPTH MAY BE INCREASED OR DECREASED ONCE THIS INFORMATION IS PROVIDED.
- NOT FOR CONSTRUCTION




PART TYPE	ITEM ON LAYOUT	DESCRIPTION	INVERT*	MAX FLOW
PREFABRICATED END CAP	A	12" BOTTOM PREFABRICATED END CAP/TYP OF ALL 12" BOTTOM CONNECTIONS AND ISOLATOR ROWS	0.90'	
PREFABRICATED END CAP	B	10" TOP PREFABRICATED END CAP/TYP OF ALL 10" TOP CONNECTIONS	1.40'	
MANIFOLD	C	10" X 10" TOP MOLDED FITTINGS	1.40'	
MANIFOLD	D	10" X 10" TOP MOLDED FITTINGS	1.40'	
PIPE CONNECTION	E	12" BOTTOM CONNECTION	0.90'	
NYLOPLAST (INLET W/ ISO ROW)	F	30" DIAMETER (24" SUMP MIN)		3.7 CFS IN
NYLOPLAST (INLET W/ ISO ROW)	G	30" DIAMETER (24" SUMP MIN)		3.7 CFS IN
NYLOPLAST (OUTLET)	H	30" DIAMETER (DESIGN BY ENGINEER)		2.0 CFS OUT

REV	DATE	DESCRIPTION	DRWN	CHK
1	10/14/19	ISSUED FOR MUNICIPAL & AGENCY REVIEW & APPROVAL	ME	WB
2	11/15/19	HILLSBOROUGH COMMENTS	ME	WB
3	12/19/19	HILLSBOROUGH COMMENTS	ME	WB
4	12/23/19	HILLSBOROUGH COMMENTS	ME	WB

4640 TRUENAN BLVD
HILLSBOROUGH, NC 27526
1-800-733-7475


STORMTECH
27 INWOOD ROAD, SUITE 3 | ROCKY HILL, CT 06067
860.568.8488 | WWW.STORMTECH.COM

SHEET
2 OF 6

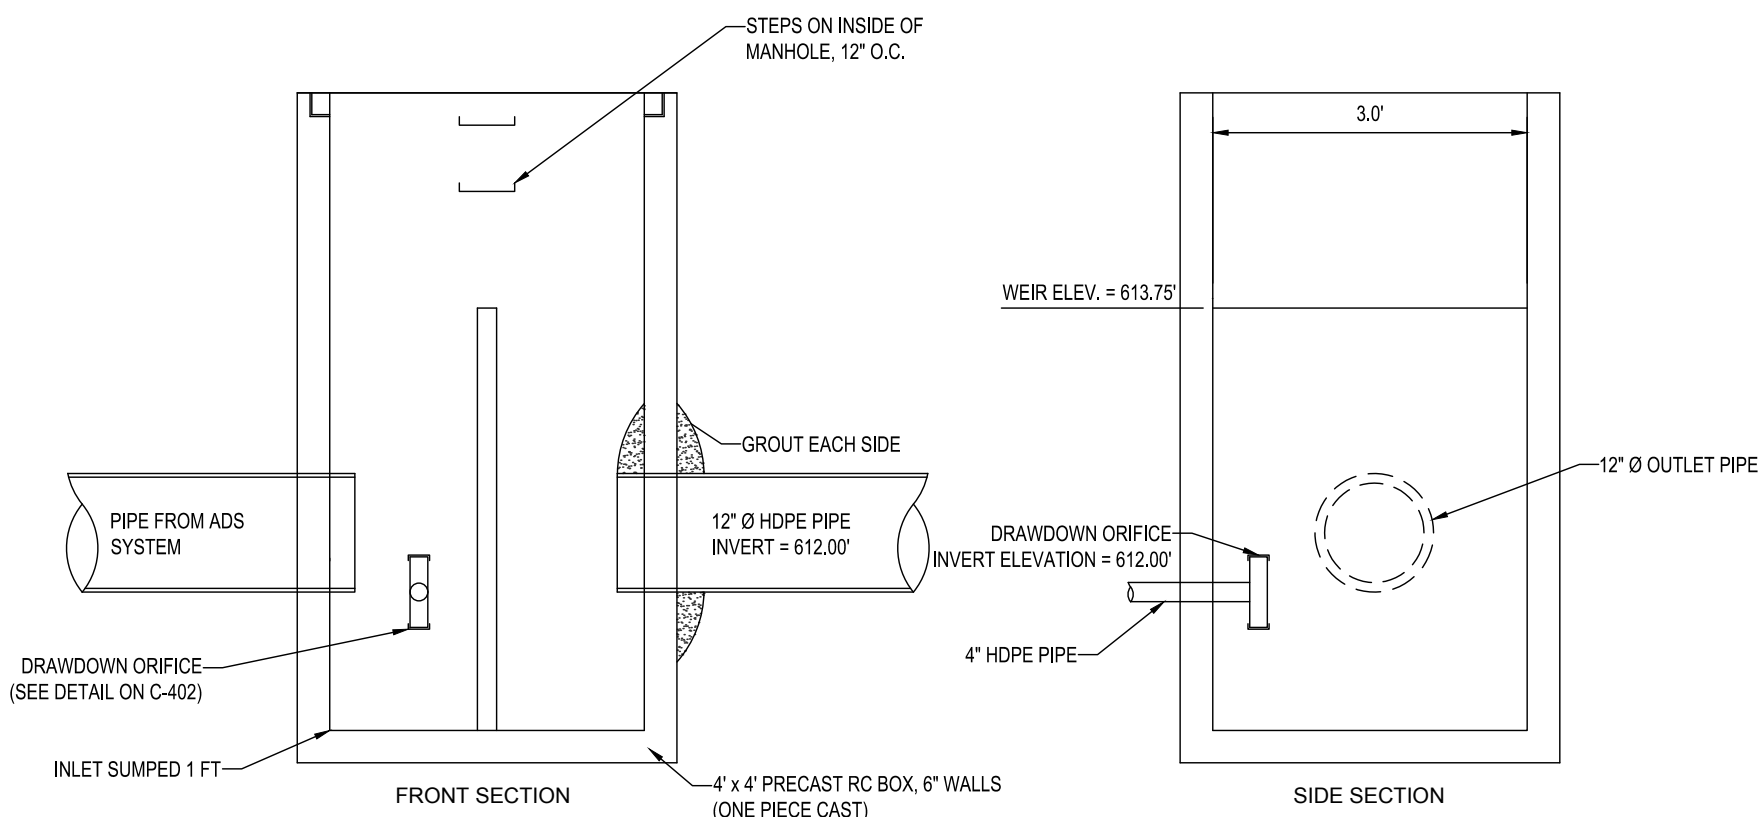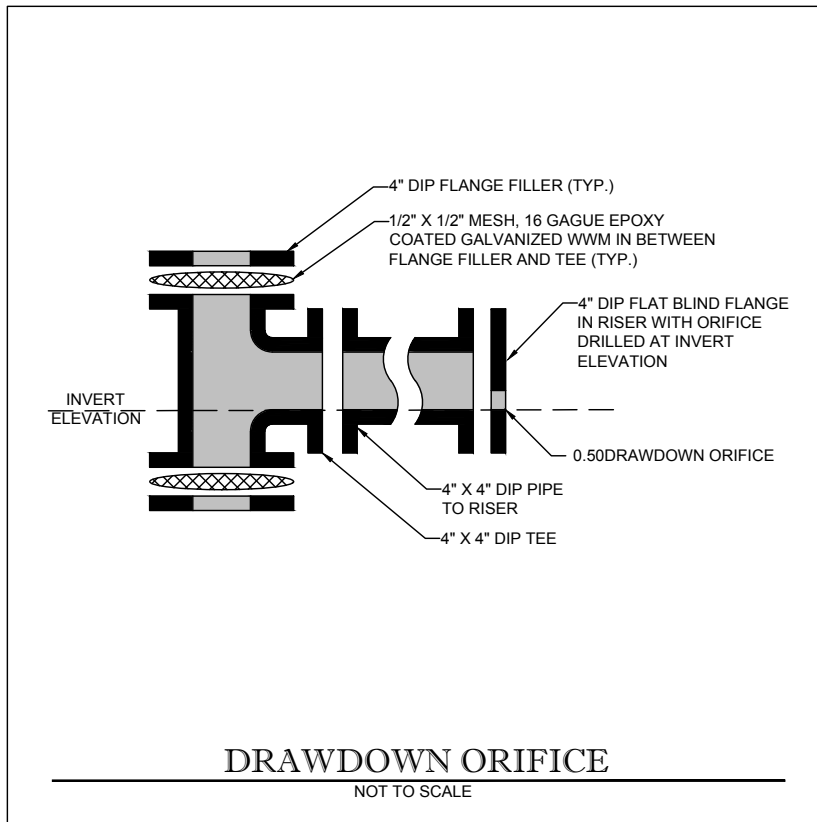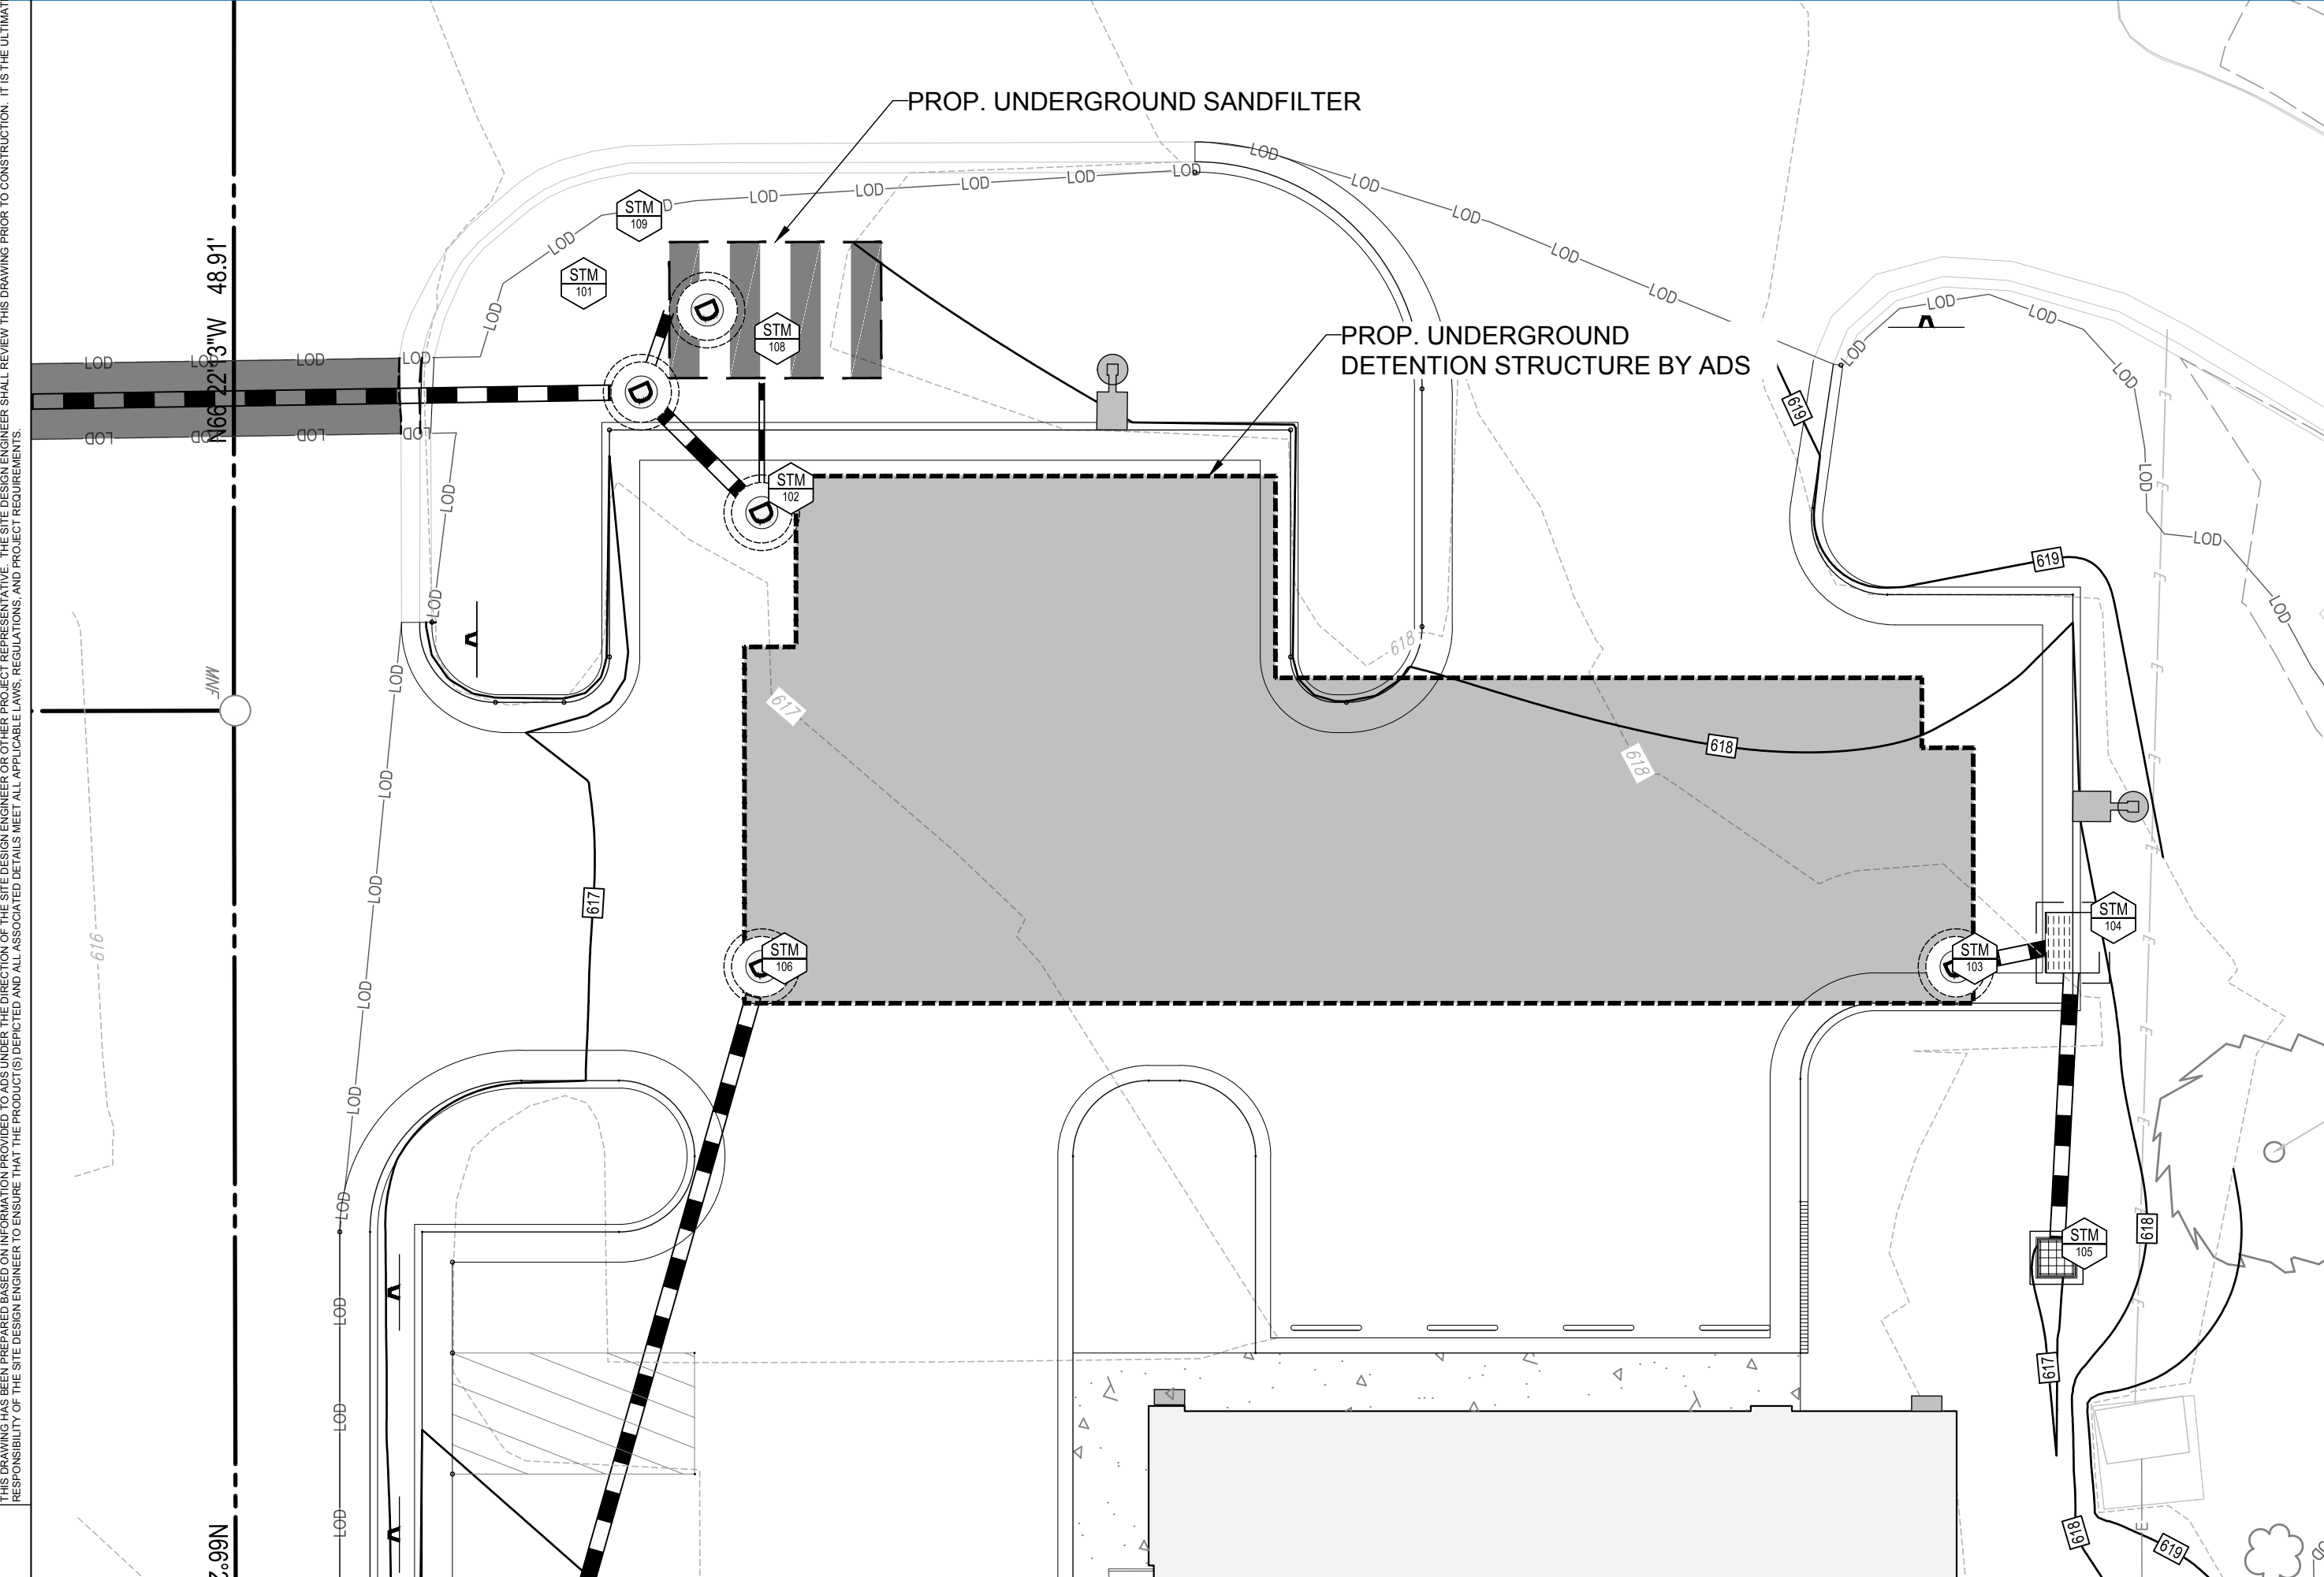


- NOTES:
- INLET TO BE PRE-CAST CONCRETE STRUCTURE. CONTRACTOR TO SUBMIT SHOP DRAWINGS FOR APPROVAL.

DETAIL STM-102
NOT TO SCALE

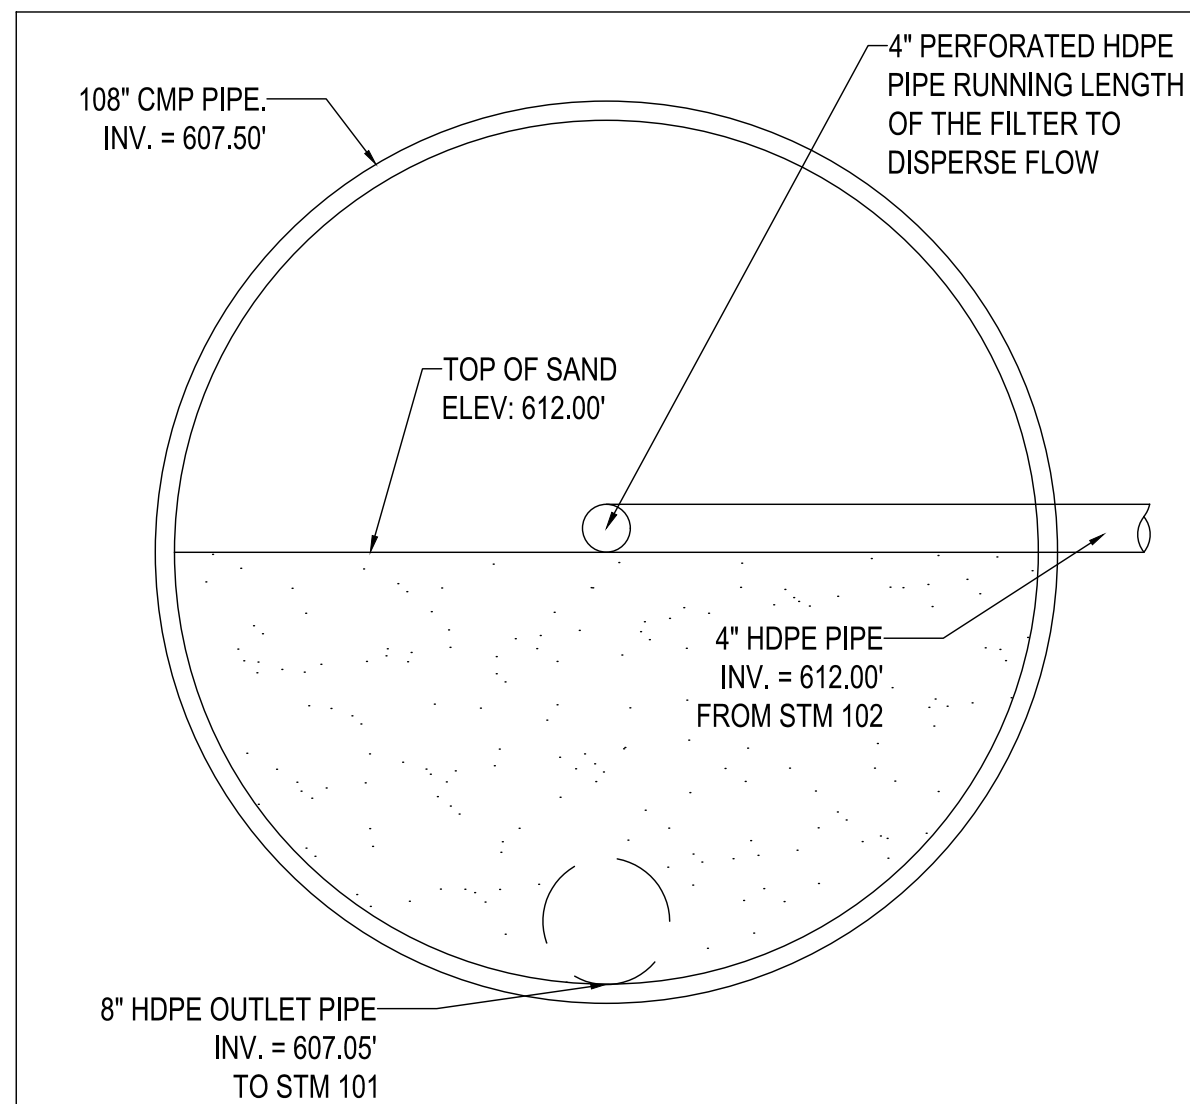

SAND FILTER DETAILED VIEWS
NOT TO SCALE

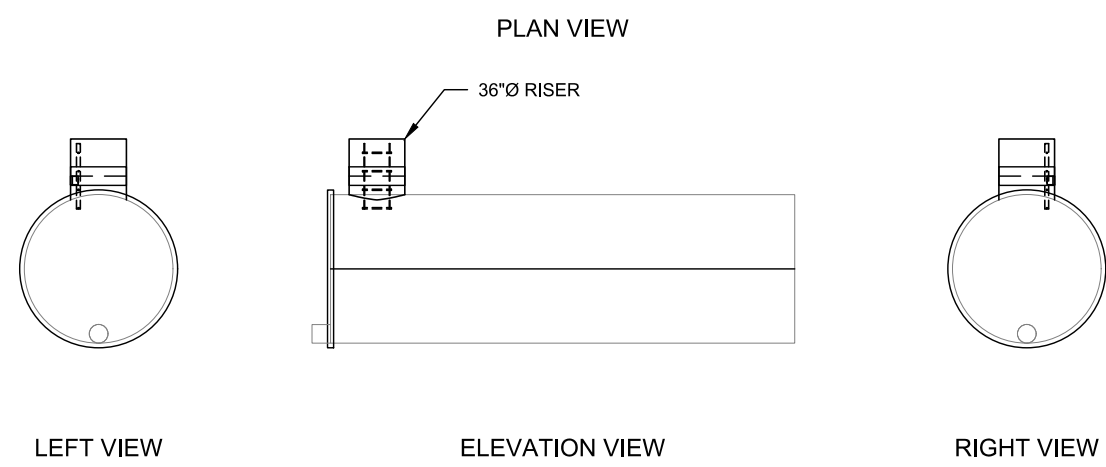

PART E
SCALE: 1" = 10'

BOHLERTM
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NCBELS P-1132

SITE CIVIL AND CONSULTING ENGINEERING
PROGRAM MANAGEMENT
LANDSCAPE ARCHITECTURE
SUSTAINABLE DESIGN
PERMITTING SERVICES
TRANSPORTATION SERVICES

REVISIONS			
REV	DATE	COMMENT	DRAWN BY
1	10/14/19	HILLSBOROUGH COMMENTS	RMG
2	11/15/19	HILLSBOROUGH COMMENTS	RMG
3	12/19/19	HILLSBOROUGH COMMENTS	RMG
4	12/23/19	HILLSBOROUGH COMMENTS	RMG

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ISSUED FOR MUNICIPAL & AGENCY REVIEW & APPROVAL

PROJECT No.:	NCR192016
DRAWN BY:	ME
CHECKED BY:	WB
DATE:	8/3/2019
CAD I.D.:	NCR192016 - GDP - 3


PROJECT: SITE PLAN
REVIEW
DOCUMENTS
FOR



PROPOSED DEVELOPMENT
HAMPTON POINTE BLVD
ORANGE COUNTY
HILLSBOROUGH, NC

BOHLERTM
ENGINEERING NC, PLLC
NCBELS P-1132

4130 PARKLAKE AVENUE, SUITE 130
RALEIGH, NC 27612
Phone: (919) 578-9000
NC@BohlerEng.com

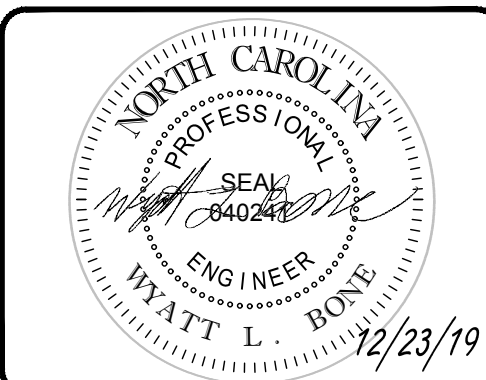

SHEET TITLE:

SCM PLAN

SHEET NUMBER:

C-402

REVISION 4 - 12/23/19

ACCEPTABLE FILL MATERIALS: STORMTECH SC-310 CHAMBER SYSTEMS				
MATERIAL LOCATION	DESCRIPTION	AASHTO MATERIAL CLASSIFICATIONS	COMPACTION / DENSITY REQUIREMENT	
D	FINAL FILL: FILL MATERIAL FOR LAYER 12 STARTS FROM THE TOP OF THE 12" LAYERS TO THE BOTTOM OF FLEXIBLE PAVEMENT OR UNPAVED FINISHED GRADE ABOVE. NOTE THAT PAVEMENT SUBBASE MAY BE PART OF THE 12" LAYER.	ANY SOIL/ROCK MATERIALS, NATIVE SOILS, OR PER ENGINEER'S PLANS. CHECK PLANS FOR PAVEMENT SUBGRADE REQUIREMENTS.	N/A	PREPARE PER SITE DESIGN ENGINEER'S PLANS, PAVED INSTALLATIONS MAY HAVE STRINGENT MATERIAL AND PREPARATION REQUIREMENTS.
C	INITIAL FILL: FILL MATERIAL FOR LAYER 12 STARTS FROM THE TOP OF THE EMBEDED STONE (B LAYERS) TO 18" (450 mm) ABOVE THE TOP OF THE CHAMBER. NOTE THAT PAVEMENT SUBBASE MAY BE A PART OF THE 12" LAYER.	GRAANULAR WELL-GRADED SUBGRADE/AGGREGATE MIXTURES: <35% FINES OR PROCESSED AGGREGATE. OR MOST PAVEMENT SUBBASE MATERIALS CAN BE USED IN LIEU OF THIS LAYER.	AASHTO M1445 A-1, A-2-A, A-3 OR AASHTO M43 3, 357, 4, 467, 5, 56, 57, 6, 67, 68, 7, 76, 8, 89, 9, 10	BEGIN COMPACTIONS AFTER 12" (300 mm) OF MATERIAL OVER THE CHAMBERS IS REACHED. COMPACT ADDITIONAL LAYERS IN 6" (150 mm) MAX LIFTS TO A MIN. 95% PROCTOR DENSITY FOR WELL GRADED MATERIAL AND 90% RELATIVE DENSITY FOR PROCESSED AGGREGATE MATERIALS. ROLLER GROSS VEHICLE WEIGHT NOT TO EXCEED 10,000 lbs (45 kN). DYNAMIC FORCE NOT TO EXCEED 20,000 lbs (90 kN).
B	EMBEDMENT STONE: FILL SURROUNDING THE CHAMBERS FROM THE FOUNDATION STONE (A LAYERS) TO THE 12" LAYER ABOVE.	CLEAN, CRUSHED, ANGULAR STONE	AASHTO M43 3, 357, 4, 467, 5, 56, 57	NO COMPACTION REQUIRED.
A	FOUNDATION STONE: FILL BELOW CHAMBERS FROM THE SUBGRADE UP TO THE FOOT (BOTTOM) OF THE CHAMBER.	CLEAN, CRUSHED, ANGULAR STONE	AASHTO M43 3, 357, 4, 467, 5, 56, 57	PLATE COMPACT OR ROLL TO ACHIEVE A FLAT SURFACE. ^{2,3}

PLEASE NOTE:

- THE LISTED AASHTO DESIGNATIONS ARE FOR GRADATIONS ONLY. THE STONE MUST ALSO BE CLEAN, CRUSHED, ANGULAR. FOR EXAMPLE, A SPECIFICATION FOR #4 STONE WOULD STATE: "CLEAN, CRUSHED, ANGULAR NO. 4 (AASHTO M43) STONE".
- STORMTECH COMPACTION REQUIREMENTS ARE MET FOR A LOCATION MATERIALS WHEN PLACED AND COMPACTED IN 6" (150 mm) MAX LIFTS USING TWO FULL COVERSAGES WITH A VIBRATORY COMPACTOR.
- WHERE INFILTRATION SURFACES MAY BE COMPROMISED BY COMPACTION, FOR STANDARD DESIGN LOAD CONDITIONS, A FLAT SURFACE MAY BE ACHIEVED BY FINING OR GRADING WITHOUT COMPACTION EQUIPMENT. FOR SPECIAL LOAD REQS, CONTACT STORMTECH FOR COMPACTION REQUIREMENTS.
- ONCE LAYER 12 IS PLACED, ANY SOLID MATERIAL CAN BE PLACED IN LAYER 12 UP TO THE FINISHED GRADE. MOST PAVEMENT SUBBASE SOILS CAN BE USED TO REPLACE THE MATERIAL REQUIREMENTS OF LAYER 12 OR 12' AT THE SITE DESIGN ENGINEER'S DISCRETION.

NOTES:

- CHAMBERS SHALL MEET THE REQUIREMENTS OF ASTM F2922 (POLYETHYLENE) OR ASTM F3416-16a (POLYPROPYLENE), "STANDARD SPECIFICATION FOR CORRUGATED WALL STORMWATER COLLECTION CHAMBERS".
- SC-310 CHAMBERS SHALL BE DESIGNED IN ACCORDANCE WITH ASTM F2787 "STANDARD PRACTICE FOR STRUCTURAL DESIGN OF THERMOPLASTIC CORRUGATED WALL STORMWATER COLLECTION CHAMBERS".
- THE SITE DESIGN ENGINEER IS RESPONSIBLE FOR ASSESSING THE BEARING RESISTANCE (ALLOWABLE BEARING CAPACITY) OF THE SUBGRADE SOILS AND THE DEPTH OF FOUNDATION STONE WITH CONSIDERATION FOR THE RANGE OF EXPECTED SOIL MOISTURE CONDITIONS.
- PERIMETER STONE MUST BE EXTENDED HORIZONTALLY TO THE EXCAVATION WALL FOR BOTH VERTICAL AND SLOPED EXCAVATION WALLS.
- REQUIREMENTS FOR HANDLING AND INSTALLATION:
 - TO MAINTAIN THE INTEGRITY OF CHAMBERS DURING SHIPPING AND HANDLING, CHAMBERS SHALL HAVE INTEGRAL INTERLOCKING STACKING LUGS.
 - TO ENSURE A SECURE JOINT DURING INSTALLATION AND BACKFILL, THE HEIGHT OF THE CHAMBER JOINT SHALL NOT BE LESS THAN 2".
 - TO ENSURE THE INTEGRITY OF THE ARCH SHAPE DURING INSTALLATION, THE ARCH STIFFNESS CONSTANT AS DEFINED IN SECTION 6.2.1 OF ASTM F2922 SHALL BE GREATER THAN OR EQUAL TO 400 LB/IN² AND 1/2 TO RESET CHAMBER DEFORMATION DURING INSTALLATION AT ELEVATED TEMPERATURES ABOVE 77 °F (25 °C). CHAMBERS SHALL BE PRODUCED FROM REFLECTIVE GOLD OR YELLOW COLORS.

SC-310 TECHNICAL SPECIFICATION
NITS

NORMAL CHAMBER SPECIFICATIONS
(SEE N-11 FOR INSTALLED LENGTH)
CHAMBER STORAGE: 14.7 CUBIC FEET (0.42 m³)
MINIMUM INSTALLED STORAGE: 30.0 CUBIC FEET (0.85 m³)
WEIGHT: 30.0 lbs (13.6 kg)

*ASSUMES 6" (152 mm) ABOVE, BELOW, AND BETWEEN CHAMBERS

PART #	STUB	A	B	C
SC310PE101 / SC310PE102	6" (150 mm)	9.6" (244 mm)	5.8" (147 mm)	—
SC310PE103 / SC310PE104	—	—	—	0.2" (5 mm)
SC310PE105 / SC310PE106	8" (200 mm)	11.9" (302 mm)	3.3" (83 mm)	0.8" (19 mm)
SC310PE107 / SC310PE108	10" (250 mm)	12.7" (323 mm)	—	0.7" (18 mm)
SC310PE109 / SC310PE110	12" (300 mm)	13.2" (335 mm)	—	0.7" (18 mm)
SC310PE111 / SC310PE112	14" (350 mm)	—	—	0.7" (18 mm)

ALL STUBS, EXCEPT FOR THE SC310PE103 ARE PLACED AT BOTTOM OF END CAP SUCH THAT THE OUTSIDE DIAMETER OF THE STUBS FLUSH WITH THE BOTTOM OF THE END CAP. FOR ADDITIONAL INFORMATION CONTACT STORMTECH AT 1-888-862-2694.

* FOR THE SC310PE128 THE 12" (300 mm) STUBS BELOW THE BOTTOM OF THE END CAP APPROXIMATELY 0.25" (6 mm). BACKFILL MATERIAL SHOULD BE REMOVED FROM BELOW THE N-12 STUB SO THAT THE FITTING SITS LEVEL.

NOTE: ALL DIMENSIONS ARE NOMINAL.

PROJECT INFORMATION	
ENGINEER	EPN NAME
PRODUCT	EPN NUMBER
MANAGER	EPN EMAIL
ADD SALES REP	SALES NAME
	SALES NUMBER
	SALES EMAIL
PROJECT NO.	



SC-310 STORMTECH CHAMBER SPECIFICATIONS

- CHAMBERS SHALL BE STORMTECH SC-310.
- CHAMBERS SHALL BE ARCH-SHAPED AND SHALL BE MANUFACTURED FROM VIRGIN, IMPACT-MODIFIED POLYPROPYLENE OR POLYETHYLENE COPOLYMERS.
- CHAMBERS SHALL MEET THE REQUIREMENTS OF ASTM F2922 (POLYETHYLENE) OR ASTM F3416-16a (POLYPROPYLENE), "STANDARD SPECIFICATION FOR CORRUGATED WALL STORMWATER COLLECTION CHAMBERS".
- CHAMBER ROWS SHALL PROVIDE CONTINUOUS, UNOBSTRUCTED INTERNAL SPACE WITH NO INTERNAL SUPPORTS THAT WOULD IMPIDE FLOW OR LIMIT ACCESS FOR INSPECTION.
- THE STRUCTURAL DESIGN OF THE CHAMBERS, THE STRUCTURAL BACKFILL, AND THE INSTALLATION REQUIREMENTS SHALL ENSURE THAT THE LOAD FACTORS SPECIFIED IN THE AASHTO LRB BRIDGE DESIGN SPECIFICATIONS, SECTION 12.12, ARE MET FOR: 1) LONG-DURATION DEAD LOADS AND 2) SHORT-DURATION LIVE LOADS, BASED ON THE AASHTO DESIGN TRUCK WITH CONSIDERATION FOR IMPACT AND MULTIPLE VEHICLE PRESENCES.
- CHAMBERS SHALL BE DESIGNED, TESTED AND ALLOWABLE LOAD CONFIGURATIONS DETERMINED IN ACCORDANCE WITH ASTM F2787 "STANDARD PRACTICE FOR STRUCTURAL DESIGN OF THERMOPLASTIC CORRUGATED WALL STORMWATER COLLECTION CHAMBERS". LOAD CONFIGURATIONS SHALL INCLUDE: 1) INSTANTANEOUS (<1 MIN) AASHTO DESIGN TRUCK LIVE LOAD ON MINIMUM COVER 2) MAXIMUM PERMANENT (24 HRS) COVER LOAD AND 3) ALLOWABLE COVER WITH PARKED (4 HRS) AASHTO DESIGN TRUCK.
- REQUIREMENTS FOR HANDLING AND INSTALLATION:
 - TO MAINTAIN THE INTEGRITY OF CHAMBERS DURING SHIPPING AND HANDLING, CHAMBERS SHALL HAVE INTEGRAL INTERLOCKING STACKING LUGS.
 - TO ENSURE A SECURE JOINT DURING INSTALLATION AND BACKFILL, THE HEIGHT OF THE CHAMBER JOINT SHALL NOT BE LESS THAN 2".
 - TO ENSURE THE INTEGRITY OF THE ARCH SHAPE DURING INSTALLATION, THE ARCH STIFFNESS CONSTANT AS DEFINED IN SECTION 6.2.1 OF ASTM F2922 SHALL BE GREATER THAN OR EQUAL TO 400 LB/IN² AND 1/2 TO RESET CHAMBER DEFORMATION DURING INSTALLATION AT ELEVATED TEMPERATURES ABOVE 77 °F (25 °C). CHAMBERS SHALL BE PRODUCED FROM REFLECTIVE GOLD OR YELLOW COLORS.
- ONLY CHAMBERS THAT ARE APPROVED BY THE SITE DESIGN ENGINEER WILL BE ALLOWED. UPON REQUEST BY THE SITE DESIGN ENGINEER OR OWNER, THE CHAMBER MANUFACTURER SHALL SUBMIT A STRUCTURAL EVALUATION FOR APPROVAL, BEFORE DELIVERING CHAMBERS TO THE PROJECT SITE AS FOLLOWS:
 - THE STRUCTURAL EVALUATION SHALL BE SEALED BY A REGISTERED PROFESSIONAL ENGINEER.
 - THE STRUCTURAL EVALUATION SHALL DEMONSTRATE THAT THE SAFETY FACTORS ARE GREATER THAN OR EQUAL TO 1.56 FOR DEAD LOAD AND 1.53 FOR LIVE LOAD. THE MINIMUM REQUIRED BY ASTM F2787 AND BY SECTIONS 3 AND 12.12 OF THE AASHTO LRB BRIDGE DESIGN SPECIFICATIONS FOR THERMOPLASTIC PE.
 - THE TEST DERIVED CRISP MODULUS AS SPECIFIED IN ASTM F2922 SHALL BE USED FOR PERMANENT DEAD LOAD DESIGN, EXCEPT THAT IT SHALL BE THE 10% MODULUS USED FOR DESIGN.
- CHAMBERS AND END CAPS SHALL BE PRODUCED AT AN ISO 9001 CERTIFIED MANUFACTURING FACILITY.

IMPORTANT - NOTES FOR THE BIDDING AND INSTALLATION OF THE SC-310 SYSTEM


- STORMTECH SC-310 CHAMBERS SHALL NOT BE INSTALLED UNTIL THE MANUFACTURER'S REPRESENTATIVE HAS COMPLETED A PRE-CONSTRUCTION MEETING WITH THE INSTALLERS.
- STORMTECH SC-310 CHAMBERS SHALL BE INSTALLED IN ACCORDANCE WITH THE "STORMTECH SC-310SC-76DC-760 CONSTRUCTION GUIDE".
- CHAMBERS ARE NOT TO BE BACKFILLED WITH A DOZER OR AN EXCAVATOR SITUATED OVER THE CHAMBERS. STORMTECH RECOMMENDS 3 BACKFILL METHODS:
 - STORMKOTER LOCATED OFF THE CHAMBER BED.
 - BACKFILL AS ROWS ARE BUILT USING AN EXCAVATOR ON THE FOUNDATION STONE OR SUBGRADE.
 - BACKFILL FROM OUTSIDE THE EXCAVATION USING A LONG BOOM HIRE OR EXCAVATOR.
- THE FOUNDATION STONE SHALL BE LEVELLED AND COMPACTED PRIOR TO PLACING CHAMBERS.
- JOINTS BETWEEN CHAMBERS SHALL BE PROPERLY SEATED PRIOR TO PLACING STONE.
- MAINTAIN MINIMUM 4" (100 mm) SPACING BETWEEN THE CHAMBER ROWS.
- EMBEDED STONE SURROUNDING CHAMBERS MUST BE A CLEAN, CRUSHED, ANGULAR STONE 3/4" (20-50 mm).
- THE CONTRACTOR MUST REPORT ANY DISCREPANCIES WITH CHAMBER FOUNDATION MATERIALS BEARING CAPACITIES TO THE SITE DESIGN ENGINEER.
- AOS RECOMMENDS THE USE OF "FLEXSTORM CATCH IT" INSERTS DURING CONSTRUCTION FOR ALL INLETS TO PROTECT THE SUBSURFACE STORMWATER MANAGEMENT SYSTEM FROM CONSTRUCTION SITE RUNOFF.

NOTES FOR CONSTRUCTION EQUIPMENT

- STORMTECH SC-310 CHAMBERS SHALL BE INSTALLED IN ACCORDANCE WITH THE "STORMTECH SC-310SC-76DC-760 CONSTRUCTION GUIDE".
 - NO EQUIPMENT IS ALLOWED ON BARE CHAMBERS.
 - NO RUBBER Tired LOADERS, DUMP TRUCKS, OR EXCAVATORS ARE ALLOWED UNTIL PROPER FILL DEPTHS ARE REACHED IN ACCORDANCE WITH THE STORMTECH SC-310SC-76DC-760 CONSTRUCTION GUIDE.
 - WEIGHT LIMITS FOR CONSTRUCTION EQUIPMENT CAN BE FOUND IN THE "STORMTECH SC-310SC-76DC-760 CONSTRUCTION GUIDE".
- FULL 36" (900 mm) OF STABILIZED COVER MATERIALS OVER THE CHAMBERS IS REQUIRED FOR DUMP TRUCK TRAVEL OR DUMPING.

USE OF A DOZER TO PUSH EMBEDED STONE BETWEEN THE ROWS OF CHAMBERS MAY CAUSE DAMAGE TO THE CHAMBERS AND IS NOT AN ACCEPTABLE BACKFILL METHOD. ANY CHAMBERS DAMAGED BY THE "DUMP AND PUSH" METHOD ARE NOT COVERED UNDER THE STORMTECH STANDARD WARRANTY.

CONTACT STORMTECH AT 1-888-862-2694 WITH ANY QUESTIONS ON INSTALLATION REQUIREMENTS OR WEIGHT LIMITS FOR CONSTRUCTION EQUIPMENT.

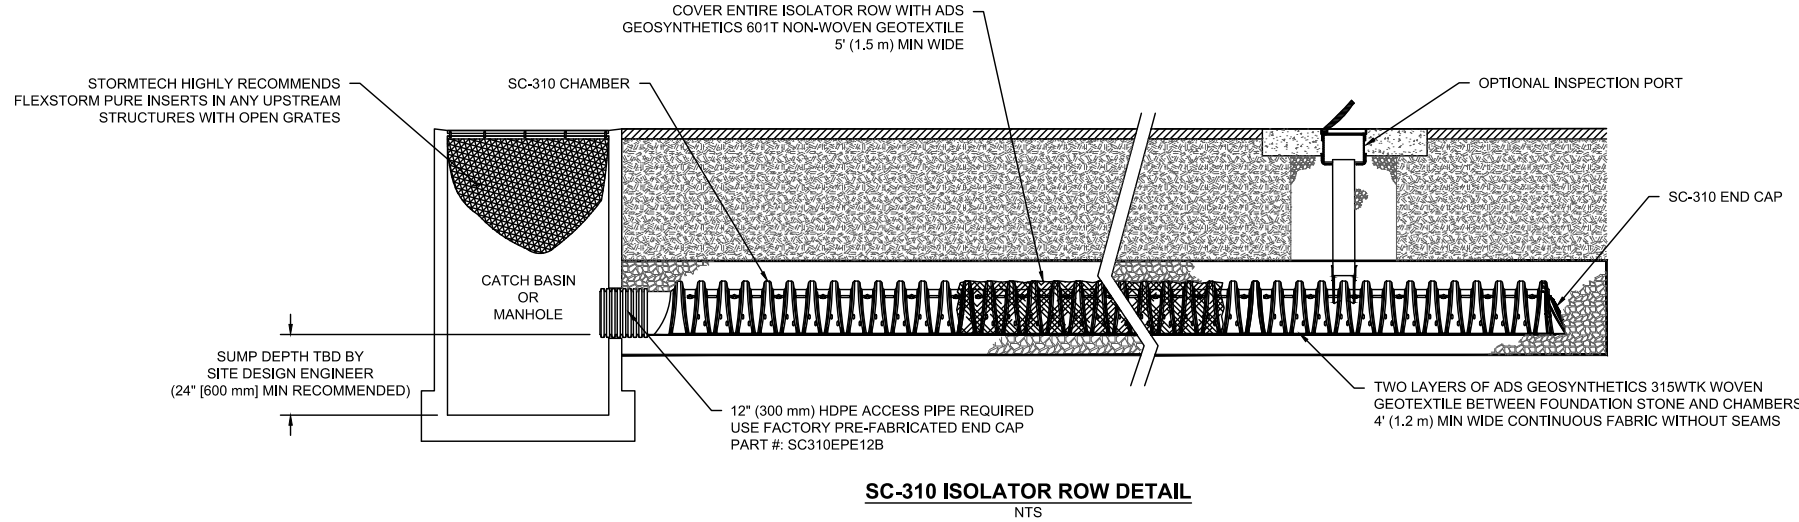


INSPECTION & MAINTENANCE

- STEP 1) INSPECT ISOLATOR ROW FOR SEDIMENT
- INSPECTION PORTS (IF PRESENT)
 - REMOVED/REPLACED ON VULCANIZAST RULINE DRAIN
 - REMOVE AND CLEAN FLEXSTORM FILTER IF INSTALLED
 - USING A FLASHLIGHT AND STADIUM ROD, MEASURE DEPTH OF SEDIMENT AND RECORD ON MAINTENANCE LOG
 - LOWER A CAMERA INTO ISOLATOR ROW FOR VISUAL INSPECTION OF SEDIMENT LEVELS (OPTIONAL)
 - IF SEDIMENT IS AT OR ABOVE 1" (80 mm) PROCEED TO STEP 2. IF NOT, PROCEED TO STEP 3.
 - ALL ISOLATOR ROWS
 - REMOVE COVER FROM STRUCTURE AT UPSTREAM END OF ISOLATOR ROW
 - USING A FLASHLIGHT, PERFECT DOWN THE ISOLATOR ROW THROUGH OUTLET PIPE
 - MIRRORS OR POLES OR CAMERAS MAY BE USED TO AVOID A CONFINED SPACE ENTRY
 - IF FLOW ORS ARE REGULATORS FOR COVERED SPACE ENTRY IF FLOWING MANHOLE
 - IF SEDIMENT IS AT OR ABOVE 1" (80 mm) PROCEED TO STEP 2. IF NOT, PROCEED TO STEP 3.
- STEP 2) CLEAN OUT ISOLATOR ROW USING THE JETVAC PROCESS
- A FIXED CALIBRATED CLEANING NOZZLE WITH REAR FACING SPRAY OF 45° (1.1 m) OR MORE IS PREFERRED
 - APPLY MULTIPLE PASSES OF JETVAC UNTIL BACKFLUSH WATER IS CLEAN
 - VACUUM STRUCTURE SUMP AS REQUIRED
- STEP 3) REPLACE ALL COVERS, GRATINGS, FILTERS, AND LIDS, RECORD OBSERVATIONS AND ACTIONS.
- STEP 4) INSPECT AND CLEAN BASINS AND MANHOLES UPSTREAM OF THE STORMTECH SYSTEM.

NOTES

- INSPECT EVERY 6 MONTHS DURING THE FIRST YEAR OF OPERATION. ADJUST THE INSPECTION INTERVAL BASED ON PREVIOUS OBSERVATIONS OF SEDIMENT ACCUMULATION AND HIGH WATER ELEVATIONS.
- CONDUCT JETTING AND VACUUMING ANNUALLY OR WHEN INSPECTION SHOWS THAT MAINTENANCE IS NECESSARY.

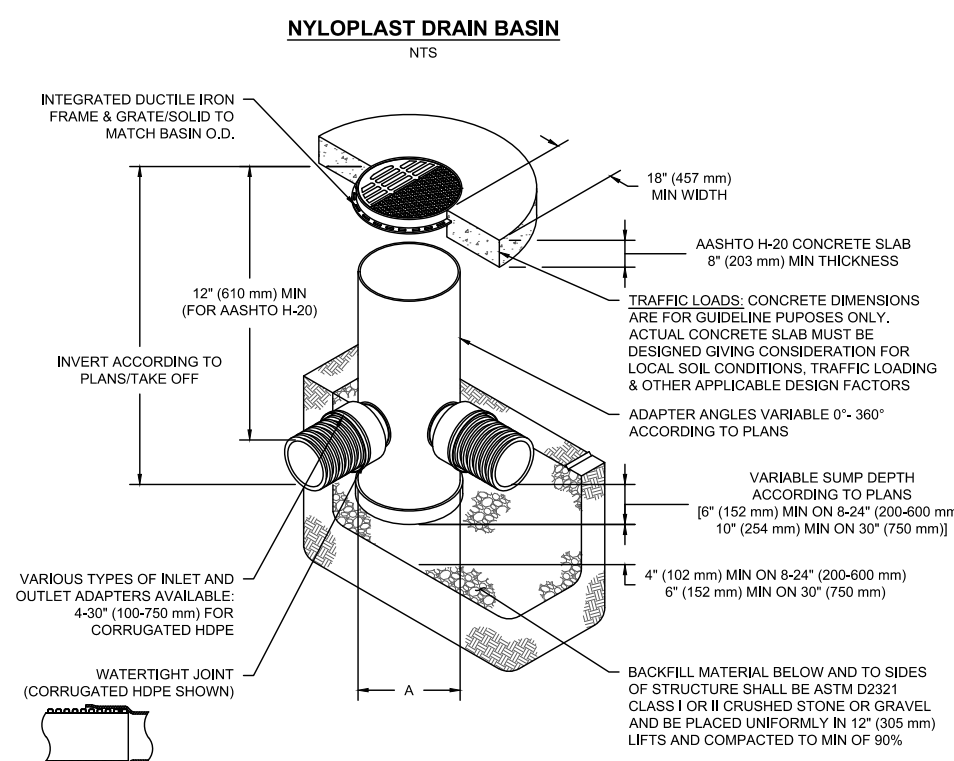

NOTES

- 6x27 (200-750 mm) GRATINGS/SOLID COVERS SHALL BE DUCTILE IRON PER ASTM A536 GRADE 15-0405
- 12x20" (300-750 mm) FRAMES SHALL BE DUCTILE IRON PER ASTM A536 GRADE 15-0405
- DRAIN BASIN TO BE CUSTOM MANUFACTURED ACCORDING TO PLAN DETAILS
- DRAINAGE CONNECTION STUBS JOINT TIGHTNESS SHALL CONFORM TO ASTM D3212 FOR CORRUGATED HDPE AND 4" MINOR QUAL. WALLS SHALL BE 3" R/C
- FOR COMPLETE DESIGN AND PRODUCT INFORMATION: WWW.NYLOPLAST-US.COM
- TO ORDER CALL: 800-821-6710

A	PART #	GRATE/SOLID COVER OPTIONS
12" (300 mm)	280AG	PEDESTALN LIGHT DUTY STANDARD LIGHT DUTY SOLID LIGHT DUTY
18" (450 mm)	281AG	PEDESTALN LIGHT DUTY STANDARD LIGHT DUTY SOLID LIGHT DUTY
12" (300 mm)	281AG	PEDESTALN AASHTO H-10 STANDARD AASHTO H-20 SOLID AASHTO H-20
18" (450 mm)	281AG	PEDESTALN AASHTO H-10 STANDARD AASHTO H-20 SOLID AASHTO H-20
12" (300 mm)	281AG	PEDESTALN AASHTO H-10 STANDARD AASHTO H-20 SOLID AASHTO H-20
18" (450 mm)	281AG	PEDESTALN AASHTO H-10 STANDARD AASHTO H-20 SOLID AASHTO H-20
24" (600 mm)	282AG	PEDESTALN AASHTO H-10 STANDARD AASHTO H-20 SOLID AASHTO H-20
36" (900 mm)	283AG	PEDESTALN AASHTO H-20 STANDARD AASHTO H-20 SOLID AASHTO H-20



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1	10/14/19	HILLSBOROUGH COMMENTS	RMG	WES
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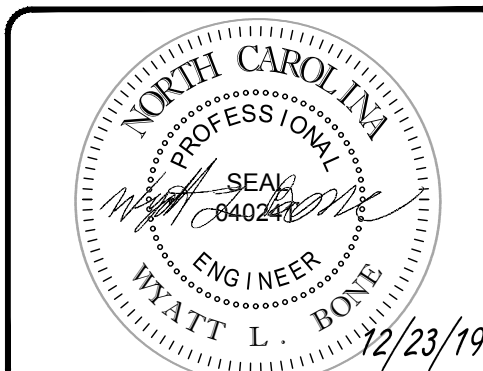
PROJECT NO.: NCR192016
DRAWN BY: ME
CHECKED BY: WB
DATE: 9/3/2019
CAD ID.: NCR192016 - GDP - 3

PROJECT: SITE PLAN REVIEW DOCUMENTS FOR



PROPOSED DEVELOPMENT
HAMPTON POINTE BLVD
ORANGE COUNTY
HILLSBOROUGH, NC

BOHLER ENGINEERING NC, PLLC
NCBELS P-1132
4130 PARKLAKE AVENUE, SUITE 130
RALEIGH, NC 27612
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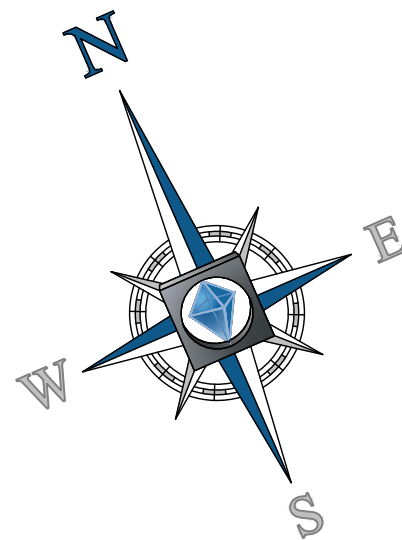
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SCM DETAILS

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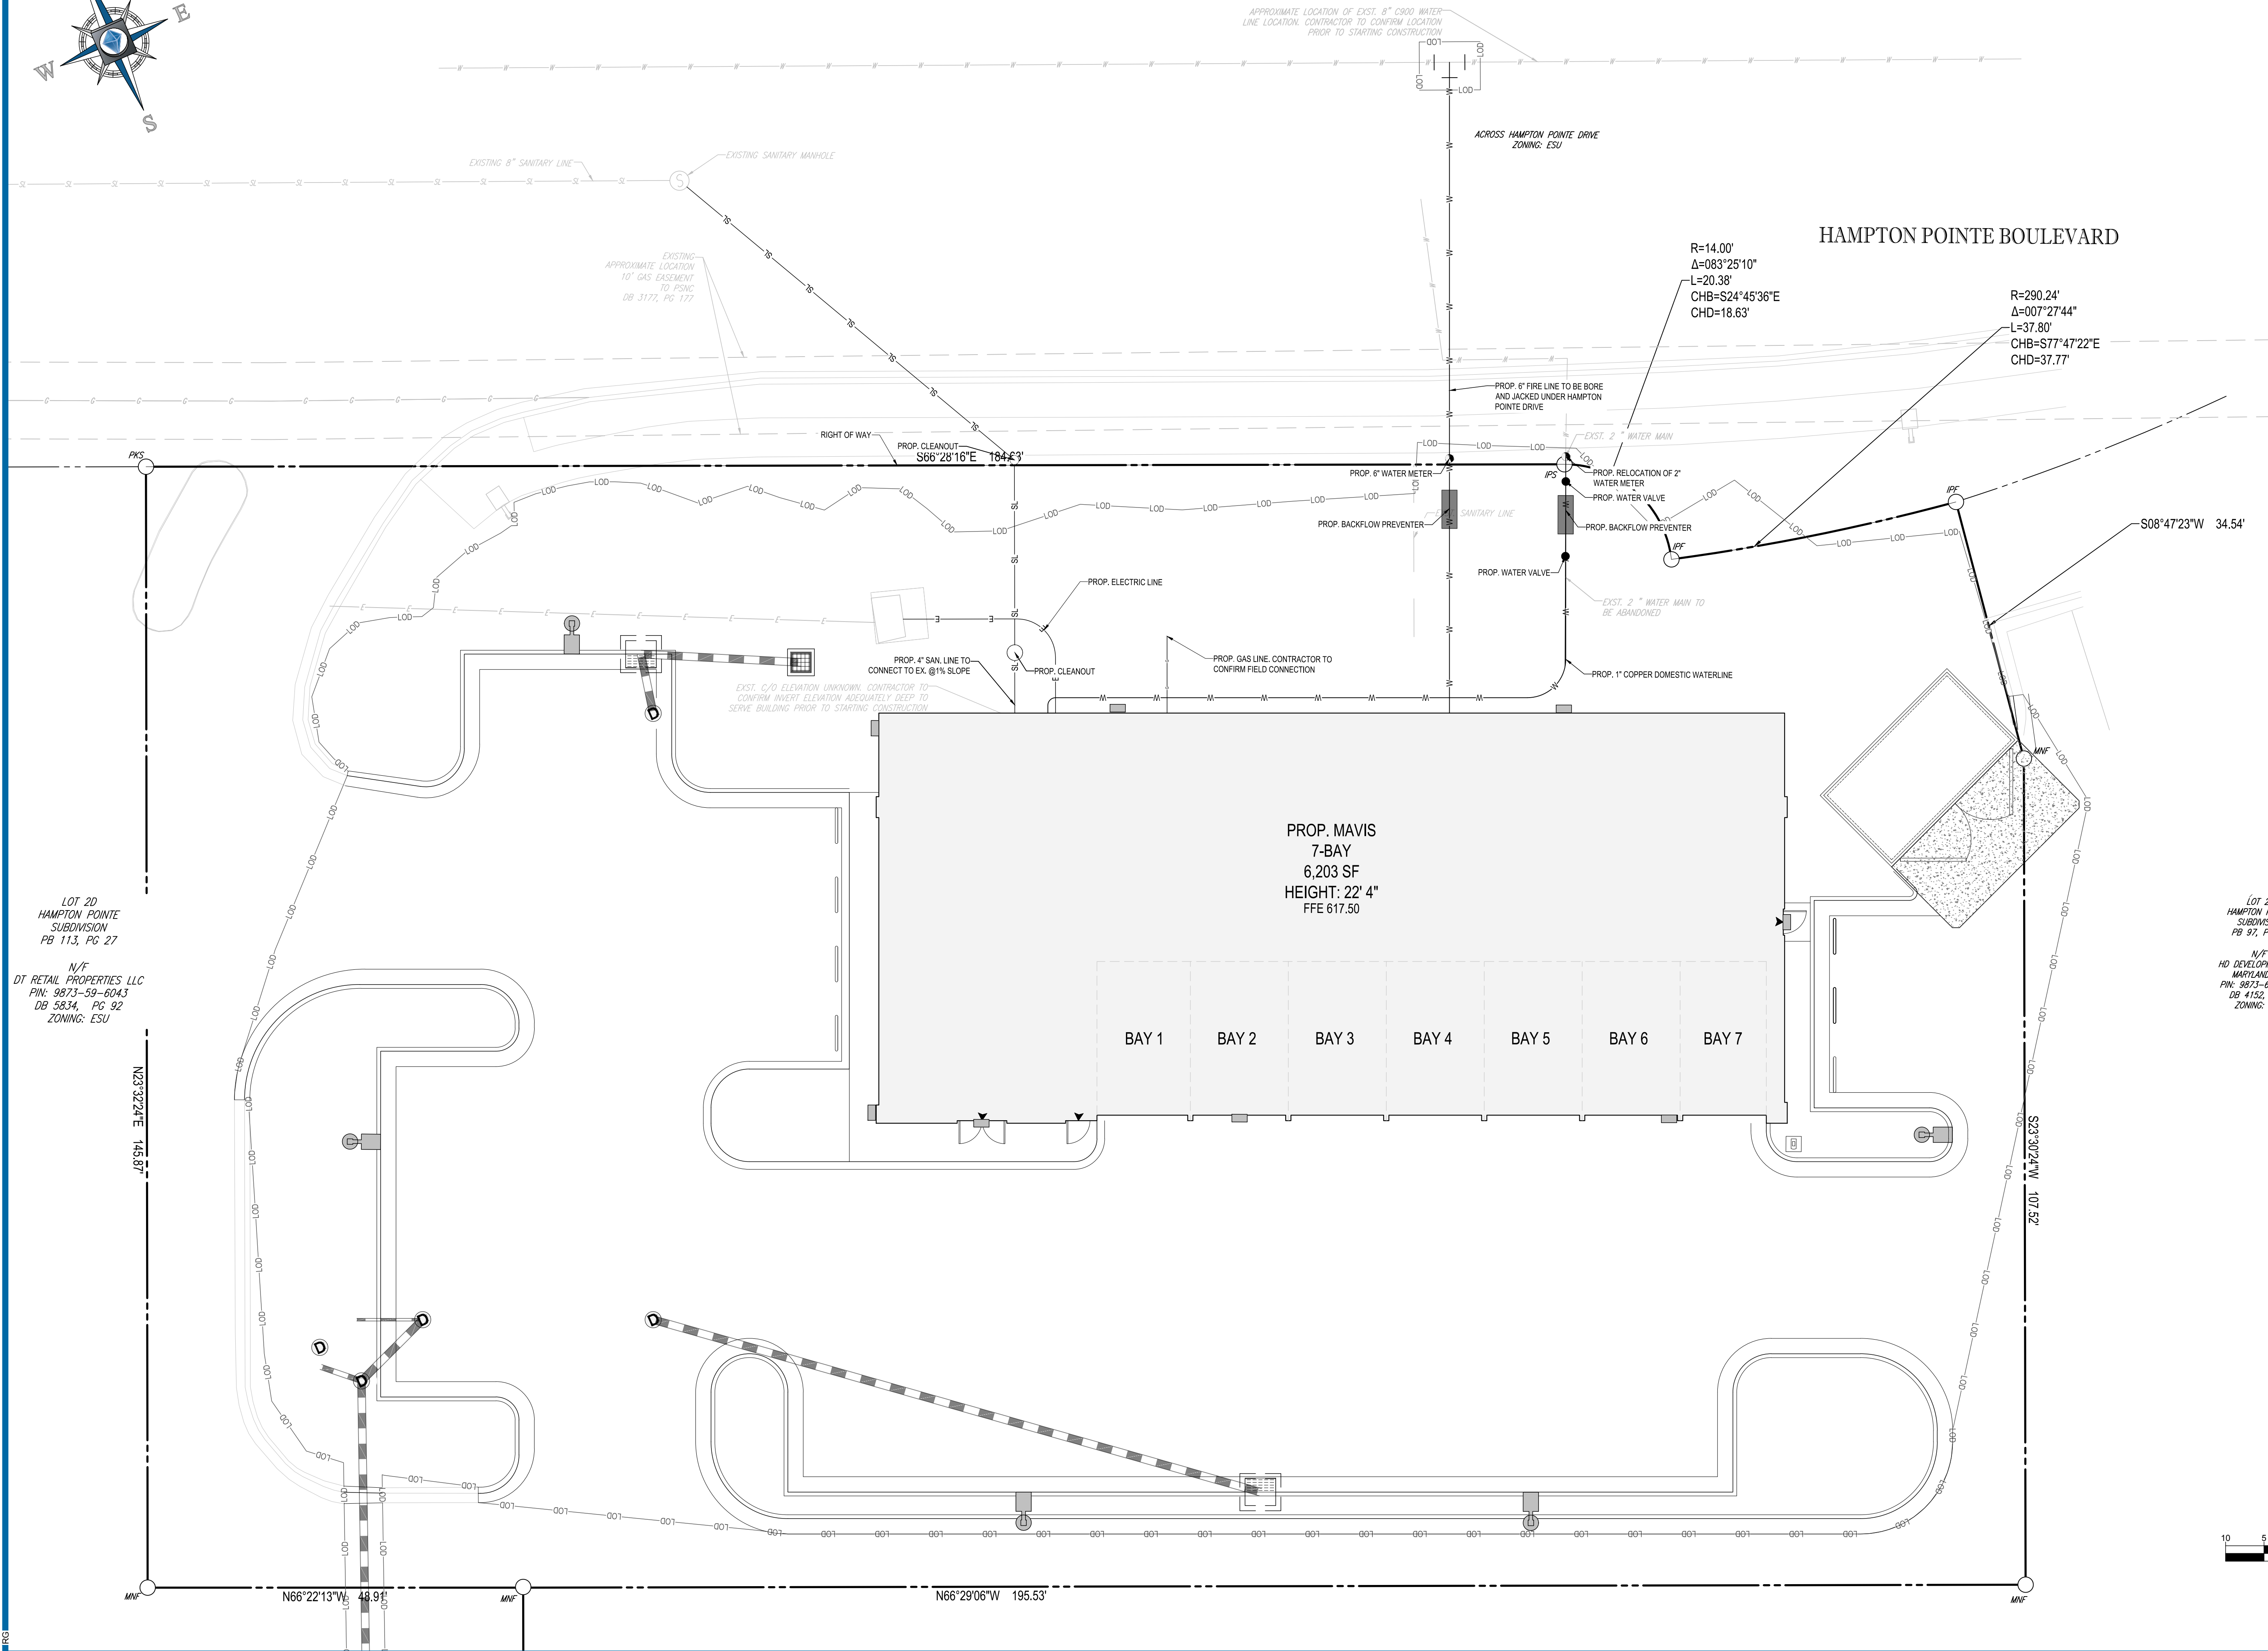
C-403

REVISION 4 - 12/23/19



SITE PLAN & ZONING NOTES:

1. ACCORDING TO THE DIVISION OF ENVIRONMENTAL QUALITY 21.0114 RULES, THE DESIGN FLOW FOR AUTO/RECREATIONAL BUSINESSES WITH RESTROOMS IS 125 GAL/PLUMBING FIXTURE.



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SITE CIVIL AND CONSULTING ENGINEERING
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PERMITTING SERVICES
TRANSPORTATION SERVICES

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PROJECT No.: NCR192016
DRAWN BY: ME
CHECKED BY: WB
DATE: 8/3/2019
CAD I.D.: NCR192016 - SSP - 3

PROJECT: SITE PLAN REVIEW DOCUMENTS FOR




PROPOSED DEVELOPMENT

HAMPTON POINTE BLVD
ORANGE COUNTY
HILLSBOROUGH, NC



4130 PARKLAKE AVENUE, SUITE 130
RALEIGH, NC 27612
Phone: (919) 578-9000
NC@BohlerEng.com

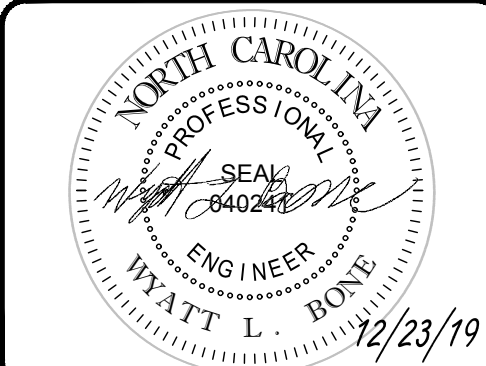


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UTILITY PLAN


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C-501

REVISION 4 - 12/23/19



EROSION CONTROL LEGEND

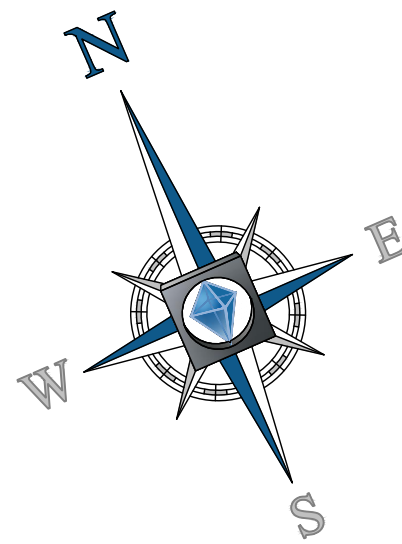

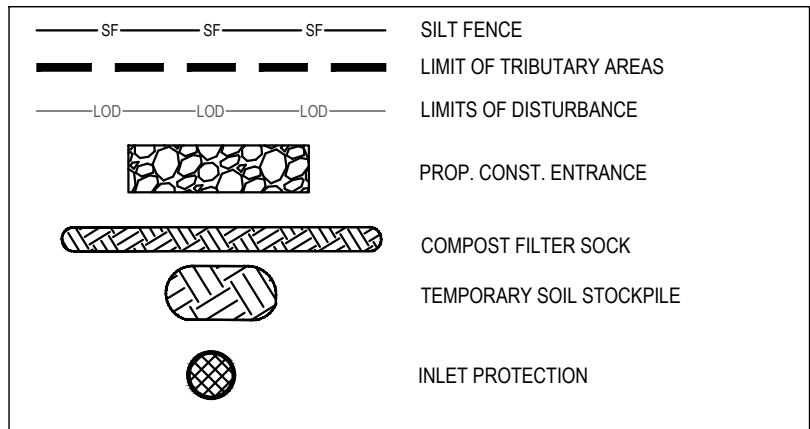PHASE I EROSION CONTROL CONSTRUCTION SEQUENCE:

1. POST REQUIRED DOCUMENTS NEAR THE PLANNED CONSTRUCTION EXIT, AND WITHIN EASY ACCESS TO THE GENERAL PUBLIC WITHOUT ENTERING THE SITE.
2. PRIOR TO ANY CLEARING OR INSTALLATION OF EROSION CONTROL DEVICES, CONTRACTOR SHALL STAKE/FAS THE LOD (WHERE STAKING IS NOT POSSIBLE/PRACTICAL, THE LOD MUST BE CONSPICUOUSLY AND PROMINENTLY MARKED TO DENOTE THE BOUNDARY). LOD MUST REMAIN CONSPICUOUSLY MARKED THROUGHOUT THE ENTIRE CONSTRUCTION PROJECT. NO DISTURBANCE IS TO TAKE PLACE BEYOND THE LOD.
3. INSTALL GRAVEL CONSTRUCTION PAD AND CONCRETE WASHOUT AREA.
4. WHERE THERE IS EXISTING PAVEMENT, PAVEMENT TO BE REMOVED BEFORE THE REST OF THE SITE IS GRADED AND SILT FENCE TO BE INSTALLED IMMEDIATELY.
5. INSTALL SILT FENCE AROUND THE SITE AS SHOWN IN PHASE I. CLEAR THE MINIMUM AMOUNT NECESSARY TO INSTALL THE SILT FENCE.
6. UPON APPROVAL FROM THE TOWN OF HILLSBOROUGH PLANNING DEPARTMENT AND ORANGE COUNTY EROSION CONTROL, BEGIN STRIPPING THE SITE (COMPLETE CLEARING AND GRUBBING TO THE EXTENT PRACTICAL TO MINIMIZE THE AMOUNT OF AREA DISTURBED AT ANY POINT IN TIME).

THE ESTIMATED DATES OF IMPLEMENTATION OF POLLUTION CONTROL MEASURES SHALL BE DOCUMENTED BY THE CONTRACTOR.

MSDCS Stormwater Discharge Permit for Construction Activities (MSDCS)

MSDCS Discharge of Storm Water and Land Resources

STABILIZATION TIMEFRAMES (Where Applicable)		
SITE AREA DESCRIPTION	STABILIZATION	TIMEFRAME EXCEPTIONS
Perimeter dikes, weirs, ditches, slopes	7 days	None
High Quality Water (HQW) Zones	7 days	None
Slopes steeper than 3:1	7 days	If slopes are 10' or less in length and are not steeper than 2:1, 14 days are allowed.
Slopes 3:1 or flatter	14 days	7 days for slopes greater than 10' in length.
All other areas with slopes flatter than 4:1	14 days	None, except for perimeters and HQW Zones.

Seeding mixture Species	Rate (lb/acre)
Rye (grain)	120
Annual lespedeza (Kobe in Piedmont and Coastal Plain, Korean in Mountains)	50

Omit annual lespedeza when duration of temporary cover is not to extend beyond June.

Seeding dates
Mountains—Above 2500 feet: Feb. 15 - May 15
Below 2500 feet: Feb. 1 - May 1
Piedmont—Jan. 1 - May 1
Coastal Plain—Dec. 1 - Apr. 15

Soil amendments
Follow recommendations of soil tests or apply 2,000 lb/acre ground agricultural limestone and 750 lb/acre 10-10-10 fertilizer.

Mulch
Apply 4,000 lb/acre straw. Anchor straw by tacking with asphalt, netting, or a mulch anchoring tool. A disk with blades set nearly straight can be used as a mulch anchoring tool.

Maintenance
Refertilize if growth is not fully adequate. Reseed, refertilize and mulch immediately following erosion or other damage.

Seeding mixture Species	Rate (lb/acre)
German millet	40

In the Piedmont and Mountains, a small-stemmed Sudangrass may be substituted at a rate of 50 lb/acre.

Seeding dates
Mountains—May 15 - Aug. 15
Piedmont—May 1 - Aug. 15
Coastal Plain—Apr. 15 - Aug. 15

Soil amendments
Follow recommendations of soil tests or apply 2,000 lb/acre ground agricultural limestone and 750 lb/acre 10-10-10 fertilizer.

Mulch
Apply 4,000 lb/acre straw. Anchor straw by tacking with asphalt, netting, or a mulch anchoring tool. A disk with blades set nearly straight can be used as a mulch anchoring tool.

Maintenance
Refertilize if growth is not fully adequate. Reseed, refertilize and mulch immediately following erosion or other damage.

Seeding mixture Species	Rate (lb/acre)
Rye (grain)	120

Seeding dates
Mountains—Aug. 15 - Dec. 15
Coastal Plain and Piedmont—Aug. 15 - Dec. 30

Soil amendments
Follow soil tests or apply 2,000 lb/acre ground agricultural limestone and 1,000 lb/acre 10-10-10 fertilizer.

Mulch
Apply 4,000 lb/acre straw. Anchor straw by tacking with asphalt, netting, or a mulch anchoring tool. A disk with blades set nearly straight can be used as a mulch anchoring tool.

Maintenance
Repair and refertilize damaged areas immediately. Topdress with 50 lb/acre of nitrogen in March. If it is necessary to extent temporary cover beyond June 15, overseed with 50 lb/acre Kobe (Piedmont and Coastal Plain) or Korean (Mountains) lespedeza in late February or early March.

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SUSTAINABLE DESIGN
PERMITTING SERVICES
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REVISIONS

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4	12/23/19	HILLSBOROUGH COMMENTS	WES

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PROJECT: SITE PLAN REVIEW DOCUMENTS FOR




PROPOSED DEVELOPMENT

HAMPTON POINTE BLVD
ORANGE COUNTY
HILLSBOROUGH, NC



4130 PARKLAKE AVENUE, SUITE 130
RALEIGH, NC 27612
Phone: (919) 578-9000
NC@BohlerEng.com

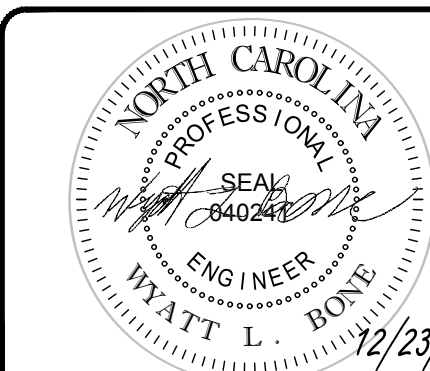

SHEET TITLE: EROSION & SEDIMENT CONTROL - PHASE I

SHEET NUMBER: C-601


REVISION 4 - 12/23/19

LOT 20
HAMPTON POINTE
SUBDIVISION
PB 113, PG 27

N/F
DT RETAIL PROPERTIES LLC
PIN: 98715-59-6043
DB 5834, PG 92
ZONING: ESU

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PHASE II EROSION CONTROL CONSTRUCTION SEQUENCE:

1. CONTINUE CLEARING, GRUBBING, AND STRIPPING THE SITE. (PHASE CLEARING AND GRUBBING TO THE EXTENT PRACTICAL TO MINIMIZE THE AMOUNT OF AREA DISTURBED AT ANY POINT IN TIME)
2. START CONSTRUCTION OF BUILDING SLAB, FOUNDATIONS, AND STRUCTURES.
3. TEMPORARILY STABILIZE, THROUGHOUT CONSTRUCTION IMMEDIATELY FOLLOWING THE COMPLETION OF THE MOST RECENT LAND DISTURBING/GRADING ACTIVITY. ANY DISTURBED AREAS, INCLUDING MATERIAL STOCKPILES THAT ARE SCHEDULED OR LIKELY TO REMAIN INACTIVE FOR 7 DAYS OR MORE.
4. IMMEDIATELY PERMANENTLY STABILIZE AREAS TO BE VEGETATED AS THEY ARE BROUGHT TO FINAL GRADE.
5. INSTALL UTILITIES, STORM SEWERS, CURBS AND GUTTERS. AS STORM DRAINS ARE BROUGHT TO GRADE, INLET PROTECTION IS TO BE INSTALLED.
6. ONCE ORANGE COUNTY INSPECTS THE SITE FOR STABILIZATION AND APPROVES TO CONTINUE CONSTRUCTION, PAVE SITE.
7. COMPLETE GRADING AND INSTALLATION OF PERMANENT STABILIZATION OVER ALL AREAS.
8. OBTAIN CONCURRENCE FROM THE OWNER THAT THE SITE HAS BEEN FULLY STABILIZED. SEDIMENT HAS BEEN REMOVED FROM STORM INLETS, AND ALL CONSTRUCTION HAS BEEN COMPLETED, THEN:
 - a. REMOVE ALL REMAINING TEMPORARY EROSION AND SEDIMENT CONTROL BEST MANAGEMENT PRACTICES (BMPs).
 - b. STABILIZE ANY AREAS DISTURBED BY THE REMOVAL OF TEMPORARY BMPs.
 - c. STABILIZE SOIL STOCKPILE.
12. DEMOBILIZE FROM SITE- CONTRACTOR SHALL NOT DEMOBILIZE UNTIL ENTIRE SITE HAS BEEN FULLY STABILIZED.

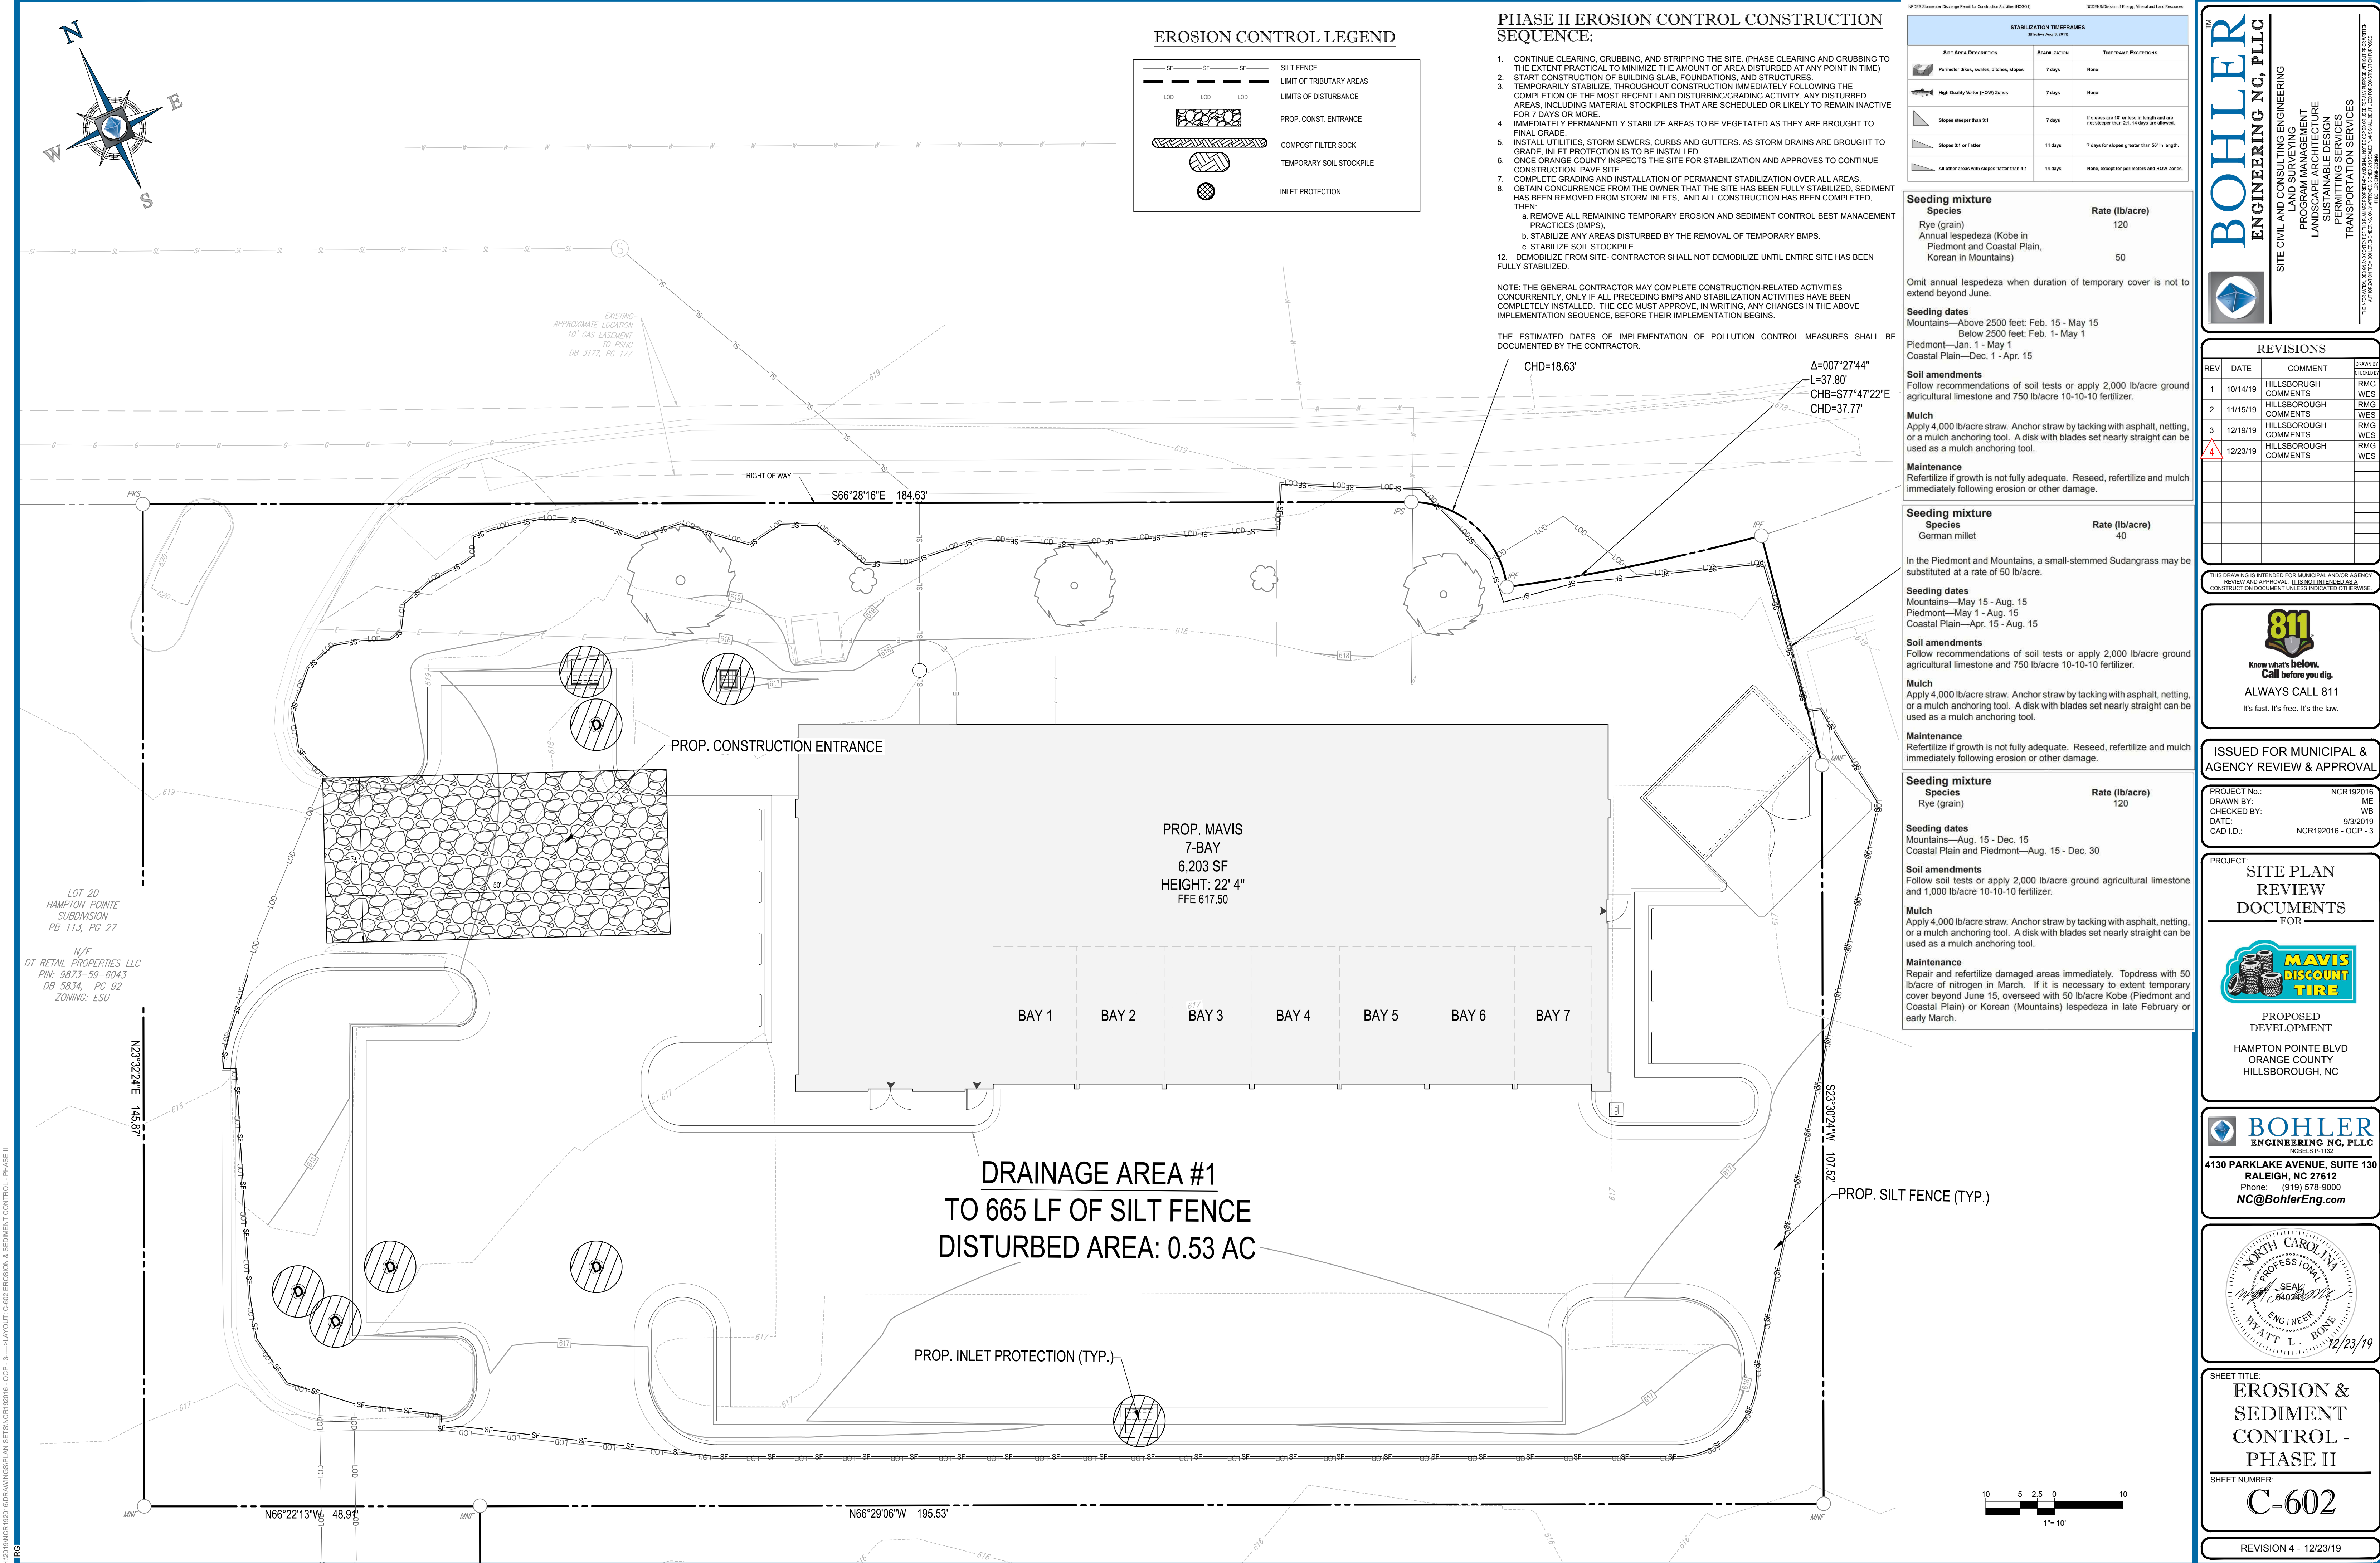NOTE: THE GENERAL CONTRACTOR MAY COMPLETE CONSTRUCTION-RELATED ACTIVITIES CONCURRENTLY, ONLY IF ALL PRECEDING BMPs AND STABILIZATION ACTIVITIES HAVE BEEN COMPLETELY INSTALLED. THE CEC MUST APPROVE, IN WRITING, ANY CHANGES IN THE ABOVE IMPLEMENTATION SEQUENCE, BEFORE THEIR IMPLEMENTATION BEGINS.

THE ESTIMATED DATES OF IMPLEMENTATION OF POLLUTION CONTROL MEASURES SHALL BE DOCUMENTED BY THE CONTRACTOR.

STABILIZATION TIMEFRAMES (Where Applicable)		
SITE AREA DESCRIPTION	STABILIZATION	TIMEFRAME EXCEPTIONS
Perimeter dikes, weirs, ditches, slopes	7 days	None
High Quality Water (HQW) Zones	7 days	None
Slopes steeper than 2:1	7 days	If slopes are 10' or less in length and are not steeper than 2:1, 14 days are allowed.
Slopes 3:1 or flatter	14 days	7 days for slopes greater than 10' in length.
All other areas with slopes flatter than 4:1	14 days	None, except for perimeters and HQW Zones.

Seeding mixture Species	Rate (lb/acre)
Rye (grain)	120
Annual lespedeza (Kobe in Piedmont and Coastal Plain, Korean in Mountains)	50

Omit annual lespedeza when duration of temporary cover is not to extend beyond June.

Seeding dates
Mountains—Above 2500 feet: Feb. 15 - May 15
Below 2500 feet: Feb. 1 - May 1
Piedmont—Jan. 1 - May 1
Coastal Plain—Dec. 1 - Apr. 15

Soil amendments
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Mulch
Apply 4,000 lb/acre straw. Anchor straw by tacking with asphalt, netting, or a mulch anchoring tool. A disk with blades set nearly straight can be used as a mulch anchoring tool.

Maintenance
Referitize if growth is not fully adequate. Reseed, referitize and mulch immediately following erosion or other damage.

Seeding mixture Species	Rate (lb/acre)
German millet	40

In the Piedmont and Mountains, a small-stemmed Sudangrass may be substituted at a rate of 50 lb/acre.

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Piedmont—May 1 - Aug. 15
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Soil amendments
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Maintenance
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Seeding mixture Species	Rate (lb/acre)
Rye (grain)	120

Seeding dates
Mountains—Aug. 15 - Dec. 15
Coastal Plain and Piedmont—Aug. 15 - Dec. 30

Soil amendments
Follow soil tests or apply 2,000 lb/acre ground agricultural limestone and 1,000 lb/acre 10-10-10 fertilizer.

Mulch
Apply 4,000 lb/acre straw. Anchor straw by tacking with asphalt, netting, or a mulch anchoring tool. A disk with blades set nearly straight can be used as a mulch anchoring tool.

Maintenance
Repair and referitize damaged areas immediately. Topdress with 50 lb/acre of nitrogen in March. If it is necessary to extent temporary cover beyond June 15, overseed with 50 lb/acre Kobe (Piedmont and Coastal Plain) or Korean (Mountains) lespedeza in late February or early March.

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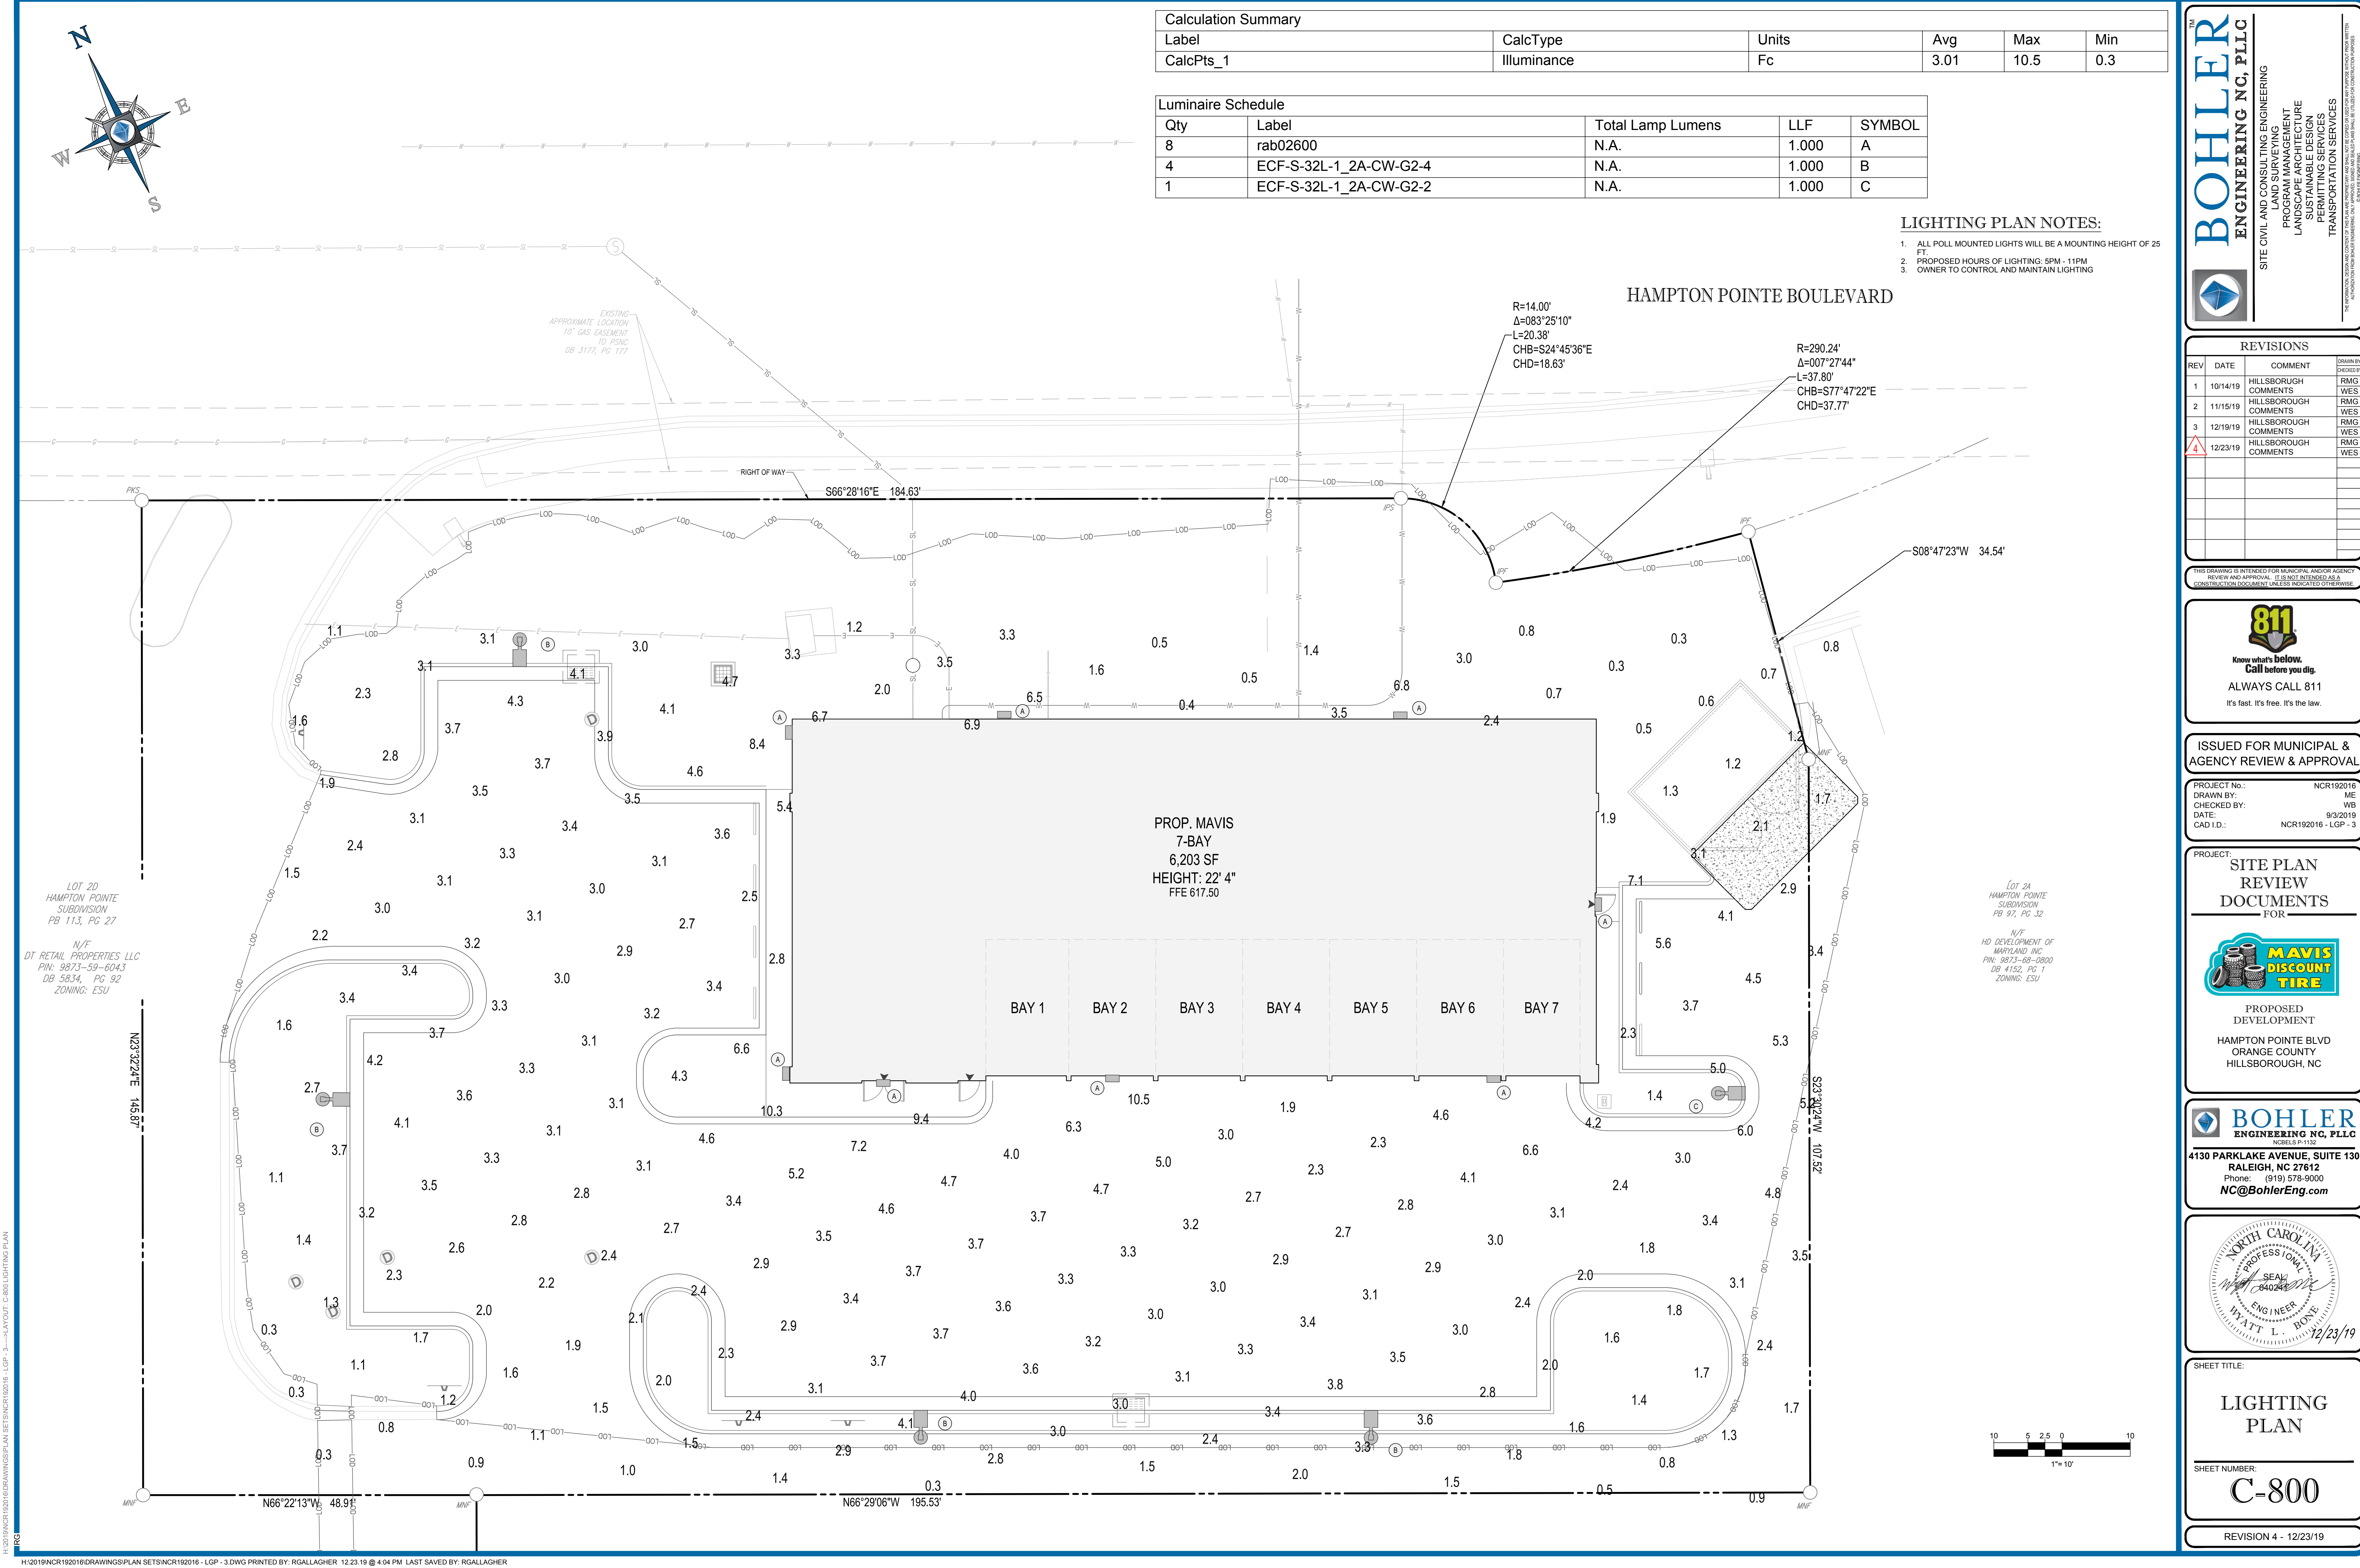
MAVIS DISCOUNT TIRE

PROPOSED DEVELOPMENT
HAMPTON POINTE BLVD
ORANGE COUNTY
HILLSBOROUGH, NC

BOHLER ENGINEERING NC, PLLC
NCBELS P-1132
4130 PARKLAKE AVENUE, SUITE 130
RALEIGH, NC 27612
Phone: (919) 578-9000
NC@BohlerEng.com

NORTH CAROLINA PROFESSIONAL ENGINEER
SEAL
WATT L. HONE
12/23/19

SHEET TITLE: **EROSION & SEDIMENT CONTROL - PHASE II**
SHEET NUMBER: **C-602**
REVISION 4 - 12/23/19



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PROJECT: SITE PLAN REVIEW DOCUMENTS FOR

MAVIS DISCOUNT TIRE

PROPOSED DEVELOPMENT
HAMPTON POINTE BLVD
ORANGE COUNTY
HILLSBOROUGH, NC

BOHLER
ENGINEERING NC, PLLC
NCBELS P-1132

4130 PARKLAKE AVENUE, SUITE 130
RALEIGH, NC 27612
Phone: (919) 578-9000
NC@BohlerEng.com

NORTH CAROLINA PROFESSIONAL SEAL
WATT L. HONE
12/23/19

SHEET TITLE:
LIGHTING PLAN

SHEET NUMBER:
C-800

REVISION 4 - 12/23/19

LANDSCAPE SPECIFICATIONS

1. SCOPE OF WORK:

THE LANDSCAPE CONTRACTOR SHALL BE REQUIRED TO PERFORM ALL CLEARING, FINISHED GRADING, SOIL PREPARATION, PERMANENT SEEDING OR SODDING, PLANTING AND MULCHING INCLUDING ALL LABOR, MATERIALS, TOOLS AND EQUIPMENT NECESSARY FOR THE COMPLETION OF THIS PROJECT, UNLESS OTHERWISE CONTRACTED BY THE GENERAL CONTRACTOR.

2. MATERIALS

- A. GENERAL - ALL HARDSCAPE MATERIALS SHALL MEET OR EXCEED SPECIFICATIONS AS OUTLINED IN THE STATE DEPARTMENT OF TRANSPORTATION'S SPECIFICATIONS.
- B. TOPSOIL - NATURAL, FRIABLE, LOAMY SILT SOIL HAVING AN ORGANIC CONTENT NOT LESS THAN 5%, A PH RANGE BETWEEN 4.5-7.0. IT SHALL BE FREE OF DEBRIS, ROCKS LARGER THAN ONE INCH (1"), WOOD, ROOTS, VEGETABLE MATTER AND CLAY CLODS.

- C. LAWN - ALL DISTURBED AREAS ARE TO BE TREATED WITH A MINIMUM SIX INCH (6") THICK LAYER OF TOPSOIL, OR AS DIRECTED BY THE LOCAL ORDINANCE OR CLIENT, AND SEEDED OR SODDED IN ACCORDANCE WITH THE PERMANENT STABILIZATION METHODS INDICATED WITHIN THE SOIL EROSION AND SEDIMENT CONTROL NOTES.
- 1.1. LAWN SEED MIXTURE SHALL BE FRESH, CLEAN NEW GERM SEED
- 1.2. SOD SHALL BE STRONGLY ROOTED, WEED AND DISEASE/PEST FREE WITH A UNIFORM THICKNESS.
- 1.3. SOD INSTALLED ON SLOPES GREATER THAN 4:1 SHALL BE PEGGED TO HOLD SOD IN PLACE.

- D. MULCH - THE MULCH AROUND THE PERIMETER OF THE BUILDING SHALL BE A 3" LAYER OF DOUBLE SHREDDED BLACK CEDAR MULCH ONLY. ALL OTHER AREAS SHALL BE MULCHED WITH A 3" LAYER OF DOUBLE SHREDDED DARK BROWN HARDWOOD BARK MULCH, UNLESS OTHERWISE STATED ON THE LANDSCAPE PLAN.

- E. FERTILIZER
- 1.1. FERTILIZER SHALL BE DELIVERED TO THE SITE MIXED AS SPECIFIED IN THE ORIGINAL UNOPENED STANDARD BAGS SHOWING WEIGHT, ANALYSIS AND NAME OF MANUFACTURER. FERTILIZER SHALL BE STORED IN A WEATHERPROOF PLACE SO THAT IT CAN BE KEPT DRY PRIOR TO USE.
- 1.2. FOR THE PURPOSE OF BIDDING, ASSUME THAT FERTILIZER SHALL BE 10% NITROGEN, 6% PHOSPHORUS AND 4% POTASSIUM BY WEIGHT. A FERTILIZER SHOULD NOT BE SELECTED WITHOUT A SOIL TEST PERFORMED BY A CERTIFIED SOIL LABORATORY.

F. PLANT MATERIAL

- 1.1. ALL PLANTS SHALL IN ALL CASES CONFORM TO THE REQUIREMENTS OF THE "AMERICAN STANDARD FOR NURSERY STOCK (ANSI Z60.1), LATEST EDITION, AS PUBLISHED BY THE AMERICAN NURSERY & LANDSCAPE ASSOCIATION.
- 1.2. IN ALL CASES, BOTANICAL NAMES SHALL TAKE PRECEDENCE OVER COMMON NAMES FOR ANY AND ALL PLANT MATERIAL.
- 1.3. PLANTS SHALL BE LEGIBLY TAGGED WITH THE PROPER NAME AND SIZE. TAGS ARE TO REMAIN ON AT LEAST ONE PLANT OF EACH SPECIES FOR VERIFICATION PURPOSES DURING THE FINAL INSPECTION.
- 1.4. TREES WITH ABRASION OF THE BARK, SUN SCALDS, DISFIGURATION OR FRESH CUTS OF LIMBS OVER 1/2", WHICH HAVE NOT BEEN COMPLETELY CALLED, SHALL BE REJECTED. PLANTS SHALL BE MONITORED ON A REGULAR BASIS FOR ADDITIONAL ROOT OR BRANCH DAMAGE AS A RESULT OF CONSTRUCTION. ROOTS SHALL NOT BE LEFT EXPOSED FOR MORE THAN ONE (1) DAY. CONTRACTOR SHALL WATER EXISTING TREES AS NEEDED TO PREVENT SHOCK OR DECLINE.
- 1.5. ALL PLANTS SHALL BE TYPICAL OF THEIR SPECIES OR VARIETY AND SHALL HAVE A NORMAL HABIT OF GROWTH, WELL DEVELOPED BRANCHES, DENSELY FOLIATED, VIGOROUS ROOT SYSTEMS AND BE FREE OF DISEASE, INSECTS, PESTS, EGGS OR LARVAE.
- 1.6. CALIPER MEASUREMENTS OF NURSERY GROWN TREES SHALL BE TAKEN AT A POINT ON THE TRUNK SIX INCHES (6") ABOVE THE NATURAL GRADE FOR TREES UP TO AND INCLUDING A FOUR INCH (4") CALIPER SIZE. IF THE CALIPER AT SIX INCHES (6") ABOVE THE GROUND EXCEEDS FOUR INCHES (4") IN CALIPER, THE CALIPER SHOULD BE MEASURED AT A POINT 12" ABOVE THE NATURAL GRADE.
- 1.7. SHRUBS SHALL BE MEASURED TO THE AVERAGE HEIGHT OR SPREAD OF THE SHRUB, AND NOT TO THE LONGEST BRANCH.
- 1.8. TREES AND SHRUBS SHALL BE HANDLED WITH CARE BY THE ROOT BALL.

3. GENERAL WORK PROCEDURES

- A. CONTRACTOR TO UTILIZE WORKMANLIKE INDUSTRY STANDARDS IN PERFORMING ALL LANDSCAPE CONSTRUCTION. THE SITE IS TO BE LEFT IN A CLEAN STATE AT THE END OF EACH WORKDAY. ALL DEBRIS, MATERIALS AND TOOLS SHALL BE PROPERLY STORED, STOCKPILED OR DISPOSED OF.

- B. WASTE MATERIALS AND DEBRIS SHALL BE COMPLETELY DISPOSED OF AT THE CONTRACTOR'S EXPENSE. DEBRIS SHALL NOT BE BURIED, INCLUDING ORGANIC MATERIALS, BUT SHALL BE REMOVED COMPLETELY FROM THE SITE.

4. SITE PREPARATIONS

- A. BEFORE AND DURING PRELIMINARY GRADING AND FINISHED GRADING, ALL WEEDS AND GRASSES SHALL BE DUG OUT BY THE ROOTS AND DISPOSED OF IN ACCORDANCE WITH GENERAL WORK PROCEDURES OUTLINED HEREIN.

- B. ALL EXISTING TREES TO REMAIN SHALL BE PRUNED TO REMOVE ANY DAMAGED BRANCHES. THE ENTIRE LIMB OF ANY DAMAGED BRANCH SHALL BE CUT OFF AT THE TRUNK. CONTRACTOR SHALL ENSURE THAT CUTS ARE SMOOTH AND STRAIGHT. ANY EXPOSED ROOTS SHALL BE CUT BACK WITH CLEAN, SHARP TOOLS AND TOPSOIL SHALL BE PLACED AROUND THE REMAINDER OF THE ROOTS. EXISTING TREES SHALL BE MONITORED ON A REGULAR BASIS FOR ADDITIONAL ROOT OR BRANCH DAMAGE AS A RESULT OF CONSTRUCTION. ROOTS SHALL NOT BE LEFT EXPOSED FOR MORE THAN ONE (1) DAY. CONTRACTOR SHALL WATER EXISTING TREES AS NEEDED TO PREVENT SHOCK OR DECLINE.

- C. CONTRACTOR SHALL ARRANGE TO HAVE A UTILITY STAKE-OUT TO LOCATE ALL UNDERGROUND UTILITIES PRIOR TO INSTALLATION OF ANY LANDSCAPE MATERIAL. UTILITY COMPANIES SHALL BE CONTACTED THREE (3) DAYS PRIOR TO THE BEGINNING OF WORK.

5. TREE PROTECTION

- A. CONTRACTOR SHALL BE RESPONSIBLE FOR THE PROTECTION OF ALL EXISTING TREES TO REMAIN. A TREE PROTECTION ZONE SHALL BE ESTABLISHED AT THE DROP INCH OR 15 FEET FROM THE TRUNK OR AT THE LIMIT OF CONSTRUCTION DISTURBANCE, WHICHEVER IS GREATER. LOCAL STANDARDS THAT MAY REQUIRE A MORE STRICT TREE PROTECTION ZONE SHALL BE HONORED.

- B. A FORTY-EIGHT INCH (48") HIGH WOODEN SNOW FENCE OR ORANGE COLORED HIGH-DENSITY 'VISI-FENCE', OR APPROVED EQUAL, MOUNTED ON STEEL POSTS SHALL BE PLACED ALONG THE BOUNDARY OF THE TREE PROTECTION ZONE. POSTS SHALL BE LOCATED AT A MAXIMUM OF EIGHT FEET (8') ON CENTER OR AS INDICATED WITHIN THE TREE PROTECTION DETAIL.

- C. WHEN THE TREE PROTECTION FENCING HAS BEEN INSTALLED, IT SHALL BE INSPECTED BY THE APPROVING AGENCY PRIOR TO DEMOLITION, GRADING, TREE CLEARING OR ANY OTHER CONSTRUCTION. THE FENCING ALONG THE TREE PROTECTION ZONE SHALL BE REGULARLY INSPECTED BY THE LANDSCAPE CONTRACTOR AND MAINTAINED UNTIL ALL CONSTRUCTION ACTIVITY HAS BEEN COMPLETED.

- D. AT NO TIME SHALL MACHINERY, DEBRIS, FALLEN TREES OR OTHER MATERIALS BE PLACED, STOCKPILED OR LEFT STANDING IN THE TREE PROTECTION ZONE.

6. SOIL MODIFICATIONS

- A. CONTRACTOR SHALL ATTAIN A SOIL TEST FOR ALL AREAS OF THE SITE PRIOR TO CONDUCTING ANY PLANTING. SOIL TESTS SHALL BE PERFORMED BY A CERTIFIED SOIL LABORATORY.

- B. LANDSCAPE CONTRACTOR SHALL REPORT ANY SOIL OR DRAINAGE CONDITIONS CONSIDERED DETRIMENTAL TO THE GROWTH OF PLANT MATERIAL. SOIL MODIFICATIONS, AS SPECIFIED HEREIN, MAY NEED TO BE CONDUCTED BY THE LANDSCAPE CONTRACTOR DEPENDING ON SITE CONDITIONS.

- C. THE FOLLOWING AMENDMENTS AND QUANTITIES ARE APPROXIMATE AND ARE FOR BIDDING PURPOSES ONLY. COMPOSITION OF AMENDMENTS SHOULD BE REVISED DEPENDING ON THE OUTCOME OF A TOPSOIL ANALYSIS PERFORMED BY A CERTIFIED SOIL LABORATORY.

- 1.1. TO INCREASE A SANDY SOIL'S ABILITY TO RETAIN WATER AND NUTRIENTS, THOROUGHLY TILL ORGANIC MATTER INTO THE TOP 6-12". USE COMPOSTED BARK, COMPOSTED LEAF MULCH OR PEAT MOSS. ALL PRODUCTS SHOULD BE COMPOSTED TO A DARK COLOR AND BE FREE OF PIECES WITH IDENTIFIABLE LEAF OR WOOD STRUCTURE. AVOID MATERIAL WITH A PH HIGHER THAN 7.5.
- 1.2. TO INCREASE DRAINAGE, MODIFY HEAVY CLAY OR SILT (MORE THAN 40% CLAY OR SILT) BY ADDING COMPOSTED PINE BARK (UP TO 30% BY VOLUME) AND/OR AGRICULTURAL GYPSUM. COARSE SAND MAY BE USED IF ENOUGH IS ADDED TO BRING THE SAND CONTENT TO MORE THAN 60% OF THE TOTAL MIX. SUBSURFACE DRAINAGE LINES MAY NEED TO BE ADDED TO INCREASE DRAINAGE.
- 1.3. MODIFY EXTREMELY SANDY SOILS (MORE THAN 85%) BY ADDING ORGANIC MATTER AND/OR DRY, SHREDDED CLAY LOAM UP TO 30% OF THE TOTAL MIX.

7. FINISHED GRADING

- A. UNLESS OTHERWISE CONTRACTED, THE LANDSCAPE CONTRACTOR SHALL BE RESPONSIBLE FOR THE INSTALLATION OF TOPSOIL AND THE ESTABLISHMENT OF FINE-GRADING WITHIN THE DISTURBANCE AREA OF THE SITE.

- B. LANDSCAPE CONTRACTOR SHALL VERIFY THAT SUBGRADE FOR INSTALLATION OF TOPSOIL HAS BEEN ESTABLISHED. THE SUBGRADE OF THE SITE MUST MEET THE FINISHED GRADE LESS THE REQUIRED TOPSOIL THICKNESS (1").

- C. ALL LAWN AND PLANTING AREAS SHALL BE GRADED TO A SMOOTH, EVEN AND UNIFORM PLANE WITH NO ABRUPT CHANGE OF SURFACE AS DERIVED WITHIN THIS SET OF CONSTRUCTION PLANS, UNLESS OTHERWISE DIRECTED BY THE PROJECT ENGINEER OR LANDSCAPE ARCHITECT.

- D. ALL PLANTING AREAS SHALL BE GRADED AND MAINTAINED TO ALLOW FREE FLOW OF SURFACE WATER IN AND AROUND THE PLANTING BEDS. STANDING WATER SHALL NOT BE PERMITTED IN PLANTING BEDS.

8. TOPSOILING

- A. CONTRACTOR SHALL PROVIDE A SIX INCH (6") THICK MINIMUM LAYER OF TOPSOIL, OR AS DIRECTED BY THE LOCAL ORDINANCE OR CLIENT, IN ALL PLANTING AREAS. TOPSOIL SHOULD BE SPREAD OVER A PREPARED SURFACE IN A UNIFORM LAYER TO ACHIEVE THE DESIRED COMPACTED THICKNESS.

- B. ON-SITE TOPSOIL MAY BE USED TO SUPPLEMENT THE TOTAL AMOUNT REQUIRED. TOPSOIL FROM THE SITE MAY BE REJECTED IF IT HAS NOT BEEN PROPERLY REMOVED, STORED AND PROTECTED PRIOR TO CONSTRUCTION.

- C. CONTRACTOR SHALL FURNISH TO THE APPROVING AGENCY AN ANALYSIS OF BOTH IMPORTED AND ON-SITE TOPSOIL TO BE UTILIZED IN ALL PLANTING AREAS. THE PH AND NUTRIENT LEVELS MAY NEED TO BE ADJUSTED THROUGH SOIL MODIFICATIONS AS NEEDED TO ACHIEVE THE REQUIRED LEVELS AS SPECIFIED IN THE MATERIALS SECTION ABOVE.

- D. ALL PLANTING AND LAWN AREAS ARE TO BE CULTIVATED TO A DEPTH OF SIX INCHES (6"). ALL DEBRIS EXPOSED FROM EXCAVATION AND CULTIVATION SHALL BE DISPOSED OF IN ACCORDANCE WITH GENERAL WORK PROCEDURES SECTION ABOVE. THE FOLLOWING SHALL BE TILLED INTO THE TOP FOUR INCHES (4") IN TWO DIRECTIONS (QUANTITIES BASED ON A 1,000 SQUARE FOOT AREA):
- 1.1. 20 POUNDS 'GROW POWER' OR APPROVED EQUAL
- 1.2. 20 POUNDS NITRO-FORM (COURSE) 38-0-0 BLUE CHIP

- E. THE SPREADING OF TOPSOIL SHALL NOT BE CONDUCTED UNDER MUDDY OR FROZEN CONDITIONS.

9. PLANTING

- A. INsofar THAT IT IS FEASIBLE, PLANT MATERIAL SHALL BE PLANTED ON THE DAY OF DELIVERY. IN THE EVENT THAT THIS IS NOT POSSIBLE, LANDSCAPE CONTRACTOR SHALL PROTECT UNINSTALLED PLANT MATERIAL. PLANTS SHALL NOT REMAIN UNPLANTED FOR LONGER THAN A THREE DAY PERIOD AFTER DELIVERY. PLANTS THAT WILL NOT BE PLANTED FOR A PERIOD OF TIME GREATER THAN THREE DAYS SHALL BE HEALED IN WITH TOPSOIL OR MULCH TO HELP PRESERVE ROOT MOISTURE.

- B. PLANTING OPERATIONS SHALL BE PERFORMED DURING PERIODS WITHIN THE PLANTING SEASON WHEN WEATHER AND SOIL CONDITIONS ARE SUITABLE AND IN ACCORDANCE WITH ACCEPTED LOCAL PRACTICE. PLANTS SHALL NOT BE INSTALLED IN TOPSOIL THAT IS IN A MUDDY OR FROZEN CONDITION.

- C. ANY INJURED ROOTS OR BRANCHES SHALL BE PRUNED TO MAKE CLEAN-CUT ENDS PRIOR TO PLANTING UTILIZING CLEAN, SHARP TOOLS. ONLY INJURED OR DISEASED BRANCHING SHALL BE REMOVED.

- D. ALL PLANTING CONTAINERS AND NON-BIODEGRADABLE MATERIALS SHALL BE REMOVED FROM ROOT BALLS DURING PLANTING. NATURAL FIBER BURLAP MUST BE CUT FROM AROUND THE TRUNK OF THE TREE AND FOLDED DOWN AGAINST THE ROOT BALL PRIOR TO BACKFILLING.

- E. POSITION TREES AND SHRUBS AT THEIR INTENDED LOCATIONS AS PER THE PLANS AND SECURE THE APPROVAL OF THE LANDSCAPE ARCHITECT PRIOR TO EXCAVATING PITS, MAKING NECESSARY ADJUSTMENTS AS DIRECTED.

- F. PRIOR TO THE ISSUANCE OF ANY CERTIFICATE OF OCCUPANCY, THE PROPOSED LANDSCAPE, AS SHOWN ON THE APPROVED LANDSCAPE PLAN, MUST BE INSTALLED, INSPECTED AND APPROVED BY THE APPROVING AGENCY. THE APPROVING AGENCY SHALL TAKE INTO ACCOUNT SEASONAL CONSIDERATIONS IN THIS REGARD AS FOLLOWS. THE PLANTING OF TREES, SHRUBS, VINES OR GROUND COVER SHALL OCCUR ONLY DURING THE FOLLOWING PLANTING SEASONS:

- 1.1. PLANTS: MARCH 15 TO DECEMBER 15
- 1.2. LAWN: MARCH 15 TO JUNE 15 OR SEPT. 1 TO DECEMBER 1

- G. PLANTINGS REQUIRED FOR A CERTIFICATE OF OCCUPANCY SHALL BE PROVIDED DURING THE NEXT APPROPRIATE SEASON AT THE MUNICIPALITY'S DISCRETION. CONTRACTOR SHOULD CONTACT APPROVING AGENCY FOR POTENTIAL SUBSTITUTIONS.

- H. FURTHERMORE, THE FOLLOWING TREE VARIETIES ARE UNUSUALLY SUSCEPTIBLE TO WINTER DAMAGE WITH TRANSPLANT SHOCK AND THE SEASONAL LACK OF NITROGEN AVAILABILITY. THE RISK OF PLANT DEATH IS GREATLY INCREASED. IT IS NOT RECOMMENDED THAT THESE SPECIES BE PLANTED DURING THE FALL PLANTING SEASON:

- | | |
|-------------------------|-----------------------|
| ACER RUBRUM | PLATANUS X ACERIFOLIA |
| BETULA VARIETIES | POPULUS VARIETIES |
| CARPINUS VARIETIES | PRUNUS VARIETIES |
| CRATAEGUS VARIETIES | PYRUS VARIETIES |
| KOELREUTERIA | QUERCUS VARIETIES |
| LIQUIDAMBER STYRACIFLUA | TILIA TOMENTOSA |
| LIRIODENDRON TULIPIFERA | ZELKOVA VARIETIES |

- I. PLANTING PITS SHALL BE DUG WITH LEVEL BOTTOMS, WITH THE WIDTH TWICE THE DIAMETER OF ROOT BALL. THE ROOT BALL SHALL REST ON UNDISTURBED GRADE. EACH PLANT PIT SHALL BE BACKFILLED IN LAYERS WITH THE FOLLOWING PREPARED SOIL MIXED THOROUGHLY:

- 1 PART PEAT MOSS
- 1 PART COMPOSTED COV MANURE BY VOLUME
- 3 PARTS TOPSOIL BY VOLUME
- 21 GRAMS 'AGRIFORM' PLANTING TABLETS (OR APPROVED EQUAL) AS FOLLOWS:
 - A) 2 TABLETS PER 1 GALLON PLANT
 - B) 3 TABLETS PER 5 GALLON PLANT
 - C) 4 TABLETS PER 15 GALLON PLANT
 - D) LARGER PLANTS: 2 TABLETS PER 1/2" CALIPER OF TRUNK

- J. FILL PREPARED SOIL AROUND BALL OF PLANT HALF-WAY AND INSERT PLANT TABLETS. COMPLETE BACKFILL AND WATER THOROUGHLY.

- K. ALL PLANTS SHALL BE PLANTED SO THAT THE TOP OF THE ROOT BALL, THE POINT AT WHICH THE ROOT FLARE BEGINS, IS SET AT GROUND LEVEL AND IN THE CENTER OF THE PIT. NO SOIL IS TO BE PLACED DIRECTLY ON TOP OF THE ROOT BALL.

- L. ALL PROPOSED TREES DIRECTLY ADJACENT TO WALKWAYS OR DRIVEWAYS SHALL BE PRUNED AND MAINTAINED TO A MINIMUM BRANCHING HEIGHT OF 7' FROM GRADE.

- M. GROUND COVER AREAS SHALL RECEIVE A 1/2" LAYER OF HUMUS RAKED INTO THE TOP 1" OF PREPARED SOIL PRIOR TO PLANTING. ALL GROUND COVER AREAS SHALL BE WEEDED AND TREATED WITH A PRE-EMERGENT CHEMICAL AS PER MANUFACTURER'S RECOMMENDATION.

- N. NO PLANT, EXCEPT GROUND COVERS, GRASSES OR VINES, SHALL BE PLANTED LESS THAN TWO FEET (2') FROM EXISTING STRUCTURES AND SIDEWALKS.

- O. ALL PLANTING AREAS AND PLANTING PITS SHALL BE MULCHED AS SPECIFIED HEREIN TO FILL THE ENTIRE BED AREA OR SAUCER. NO MULCH IS TO TOUCH THE TRUNK OF THE TREE OR SHRUB.

- P. ALL PLANTING AREAS SHALL BE WATERED IMMEDIATELY UPON INSTALLATION IN ACCORDANCE WITH THE WATERING SPECIFICATIONS AS LISTED HEREIN.

10. TRANSPLANTING (WHEN REQUIRED)

- A. ALL TRANSPLANTS SHALL BE DUG WITH INTACT ROOT BALLS CAPABLE OF SUSTAINING THE PLANT.

- B. IF PLANTS ARE TO BE STOCKPILED BEFORE REPLANTING, THEY SHALL BE HEALED IN WITH MULCH OR SOIL, ADEQUATELY WATERED AND PROTECTED FROM EXTREME HEAT, SUN AND WIND.

- C. PLANTS SHALL NOT BE DUG FOR TRANSPLANTING BETWEEN APRIL 10 AND JUNE 30.

- D. UPON REPLANTING, BACKFILL SOIL SHALL BE AMENDED WITH FERTILIZER AND ROOT GROWTH HORMONE.

- E. TRANSPLANTS SHALL BE GUARANTEED FOR THE LENGTH OF THE GUARANTEE PERIOD SPECIFIED HEREIN.

- F. IF TRANSPLANTS DIE, SHRUBS AND TREES LESS THAN SIX INCHES (6") DBH SHALL BE REPLACED IN KIND. TREES GREATER THAN SIX INCHES (6") DBH MAY BE REQUIRED TO BE REPLACED IN ACCORDANCE WITH THE MUNICIPALITY'S TREE REPLACEMENT GUIDELINES.

11. WATERING

- A. NEW PLANTINGS OR LAWN AREAS SHALL BE ADEQUATELY IRRIGATED BEGINNING IMMEDIATELY AFTER PLANTING. WATER SHALL BE APPLIED TO EACH TREE AND SHRUB IN SUCH MANNER AS NOT TO DISTURB BACKFILL AND TO THE EXTENT THAT ALL MATERIALS IN THE PLANTING HOLE ARE THOROUGHLY SATURATED. WATERING SHALL CONTINUE AT LEAST UNTIL PLANTS ARE ESTABLISHED.

- B. SITE OWNER SHALL PROVIDE WATER IF AVAILABLE ON SITE AT TIME OF PLANTING. IF WATER IS NOT AVAILABLE ON SITE, CONTRACTOR SHALL SUPPLY ALL NECESSARY WATER. THE USE OF WATERING BAGS IS RECOMMENDED FOR ALL NEWLY PLANTED TREES.

- C. IF AN IRRIGATION SYSTEM HAS BEEN INSTALLED ON THE SITE, IT SHALL BE USED TO WATER PROPOSED PLANT MATERIAL, BUT ANY FAILURE OF THE SYSTEM DOES NOT ELIMINATE THE CONTRACTOR'S RESPONSIBILITY OF MAINTAINING THE DESIRED MOISTURE LEVEL FOR VIGOROUS, HEALTHY GROWTH.

12. GUARANTEE

- A. THE LANDSCAPE CONTRACTOR SHALL GUARANTEE ALL PLANTS FOR A PERIOD OF ONE (1) YEAR FROM APPROVAL OF LANDSCAPE INSTALLATION BY THE APPROVING AGENCY. CONTRACTOR SHALL SUPPLY THE OWNER WITH A MAINTENANCE BOND FOR TEN PERCENT (10%) OF THE VALUE OF THE LANDSCAPE INSTALLATION WHICH WILL BE RELEASED AT THE CONCLUSION OF THE GUARANTEE PERIOD AND WHEN A FINAL INSPECTION HAS BEEN COMPLETED AND APPROVED BY THE OWNER OR AUTHORIZED REPRESENTATIVE.

- B. ANY DEAD OR DYING PLANT MATERIAL SHALL BE REPLACED FOR THE LENGTH OF THE GUARANTEE PERIOD. REPLACEMENT OF PLANT MATERIAL SHALL BE CONDUCTED AT THE FIRST SUCCEEDING PLANTING SEASON. ANY DEBRIS SHALL BE DISPOSED OF OFF-SITE, WITHOUT EXCEPTION.


- C. TREES AND SHRUBS SHALL BE MAINTAINED BY THE CONTRACTOR DURING CONSTRUCTION AND THROUGHOUT THE 90 DAY MAINTENANCE PERIOD AS SPECIFIED HEREIN. CULTIVATION, WEEDING, WATERING AND THE PREVENTATIVE TREATMENTS SHALL BE PERFORMED AS NECESSARY TO KEEP PLANT MATERIAL IN GOOD CONDITION AND FREE OF INSECTS AND DISEASE.

- D. LAWNS SHALL BE MAINTAINED THROUGH WATERING, FERTILIZING, WEEDING, MOWING, TRIMMING AND OTHER OPERATIONS SUCH AS ROLLING, REGARDING AND REPLANTING AS REQUIRED TO ESTABLISH A SMOOTH, ACCEPTABLE LAWN, FREE OF ERODED OR BARE AREAS.

13. CLEANUP


- A. UPON THE COMPLETION OF ALL LANDSCAPE INSTALLATION AND BEFORE THE FINAL ACCEPTANCE, THE CONTRACTOR SHALL REMOVE ALL UNUSED MATERIALS, EQUIPMENT AND DEBRIS FROM THE SITE. ALL PAVED AREAS ARE TO BE CLEANED.

- B. THE SITE SHALL BE CLEANED AND LEFT IN A NEAT AND ACCEPTABLE CONDITION AS APPROVED BY THE OWNER OR AUTHORIZED REPRESENTATIVE.

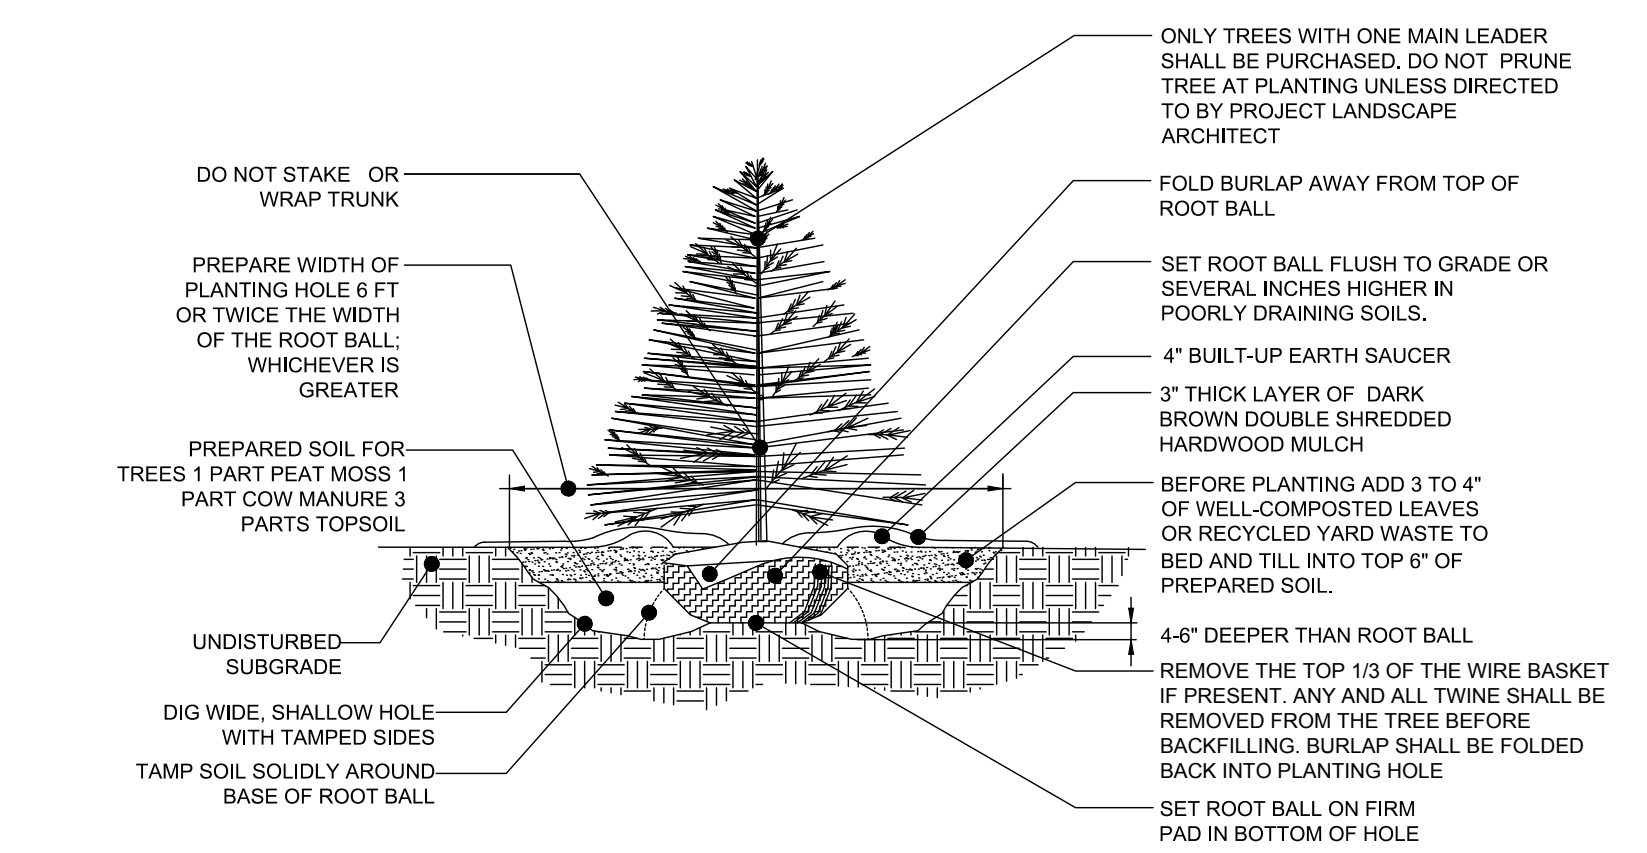


EVERGREEN TREE PLANTING DETAIL

NOT TO SCALE

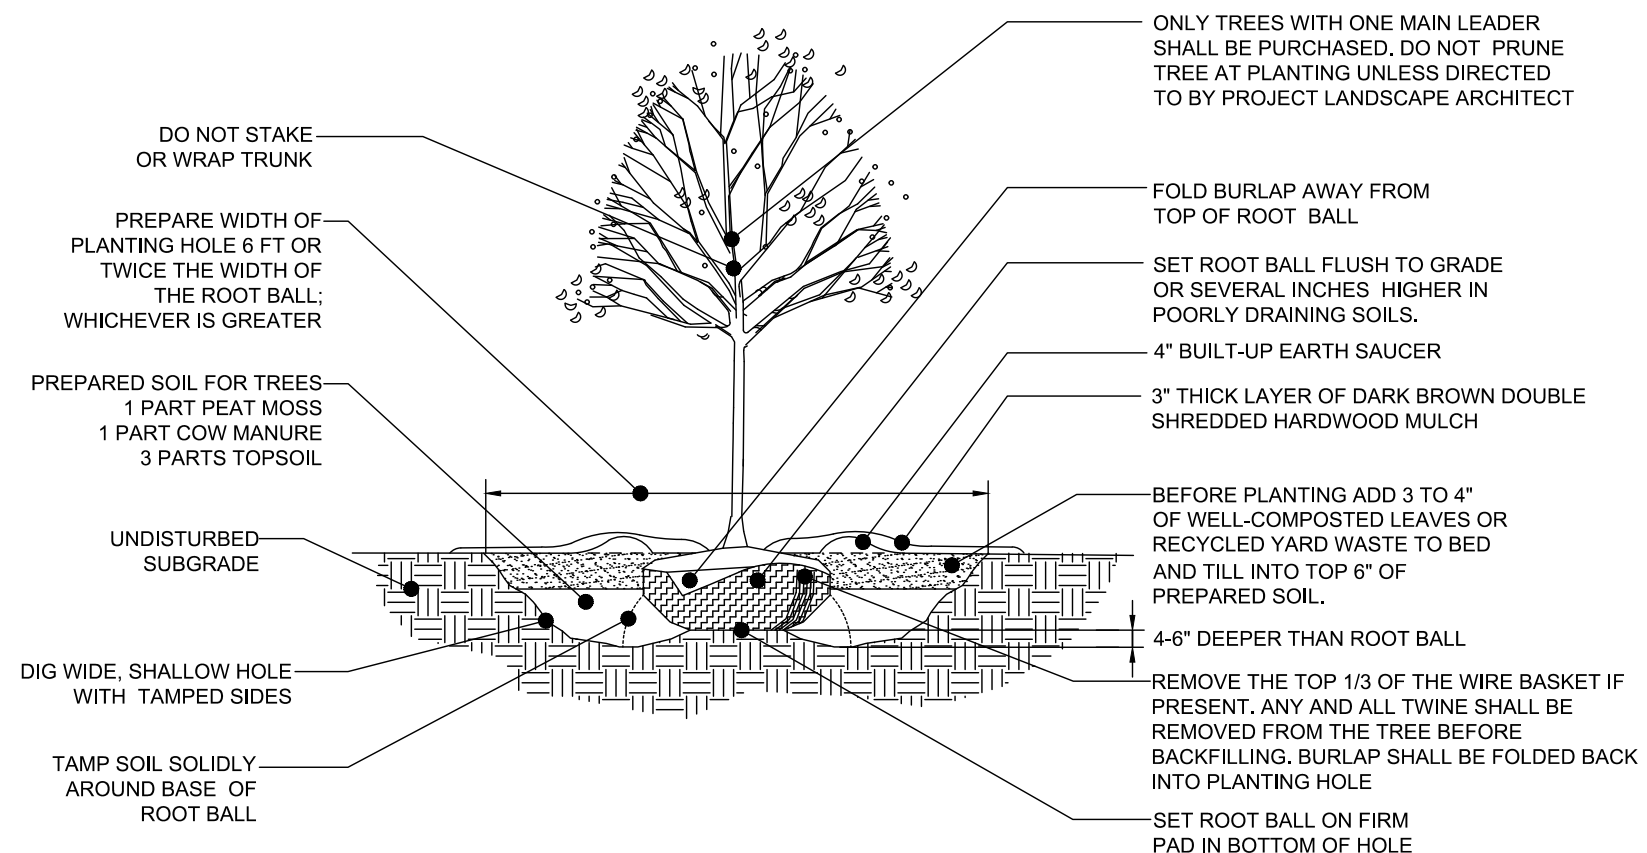

DECIDUOUS TREE PLANTING DETAIL


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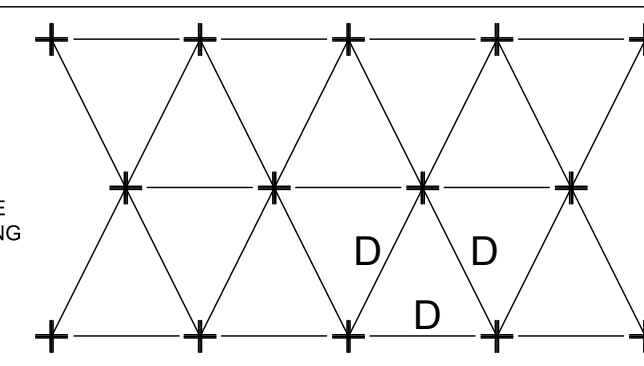
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DECIDUOUS AND EVERGREEN SHRUB PLANTING DETAIL
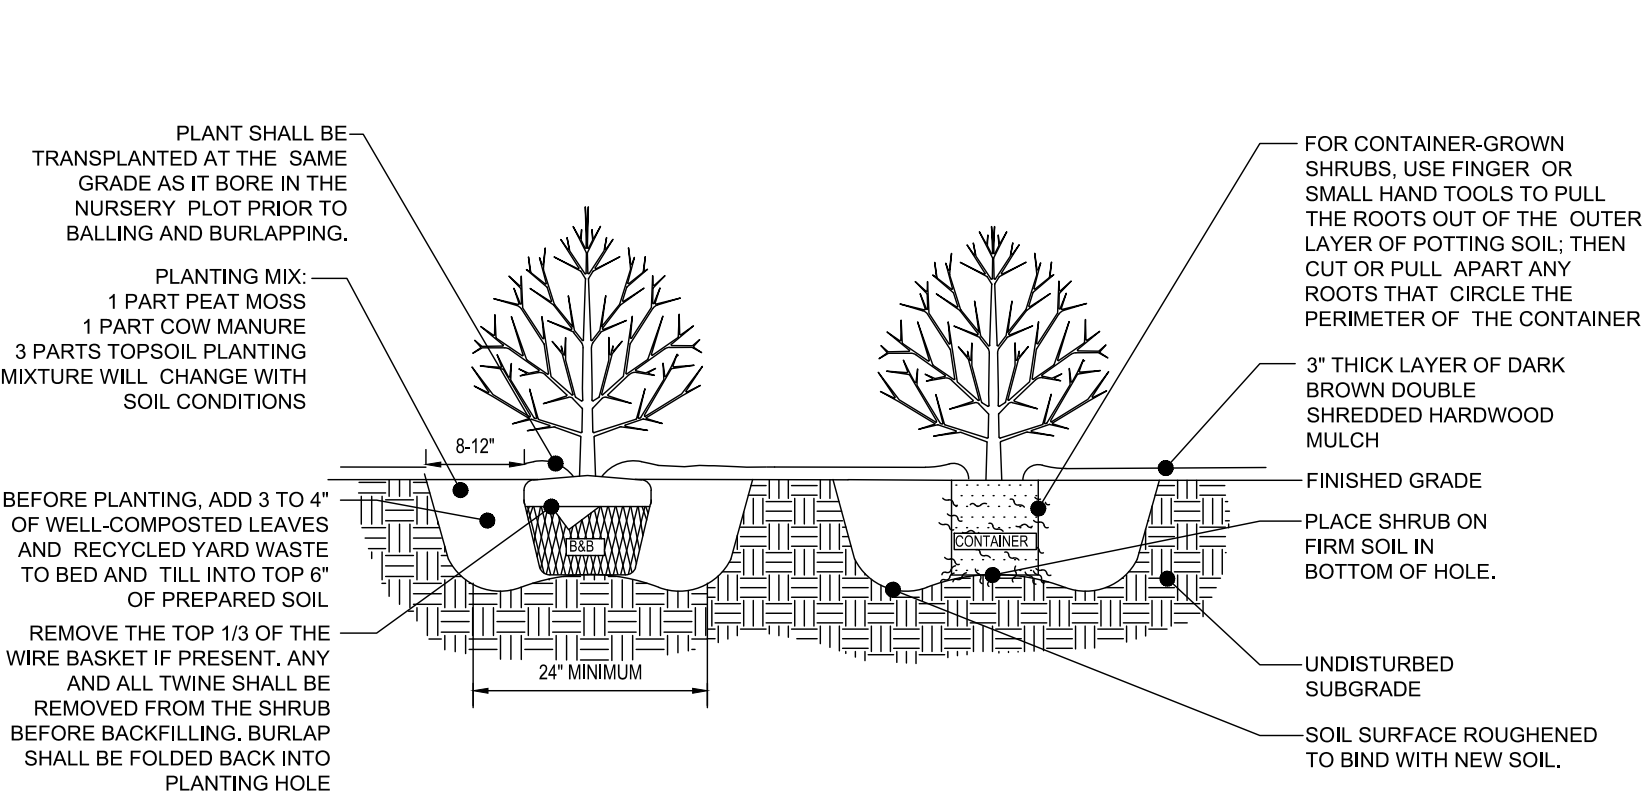
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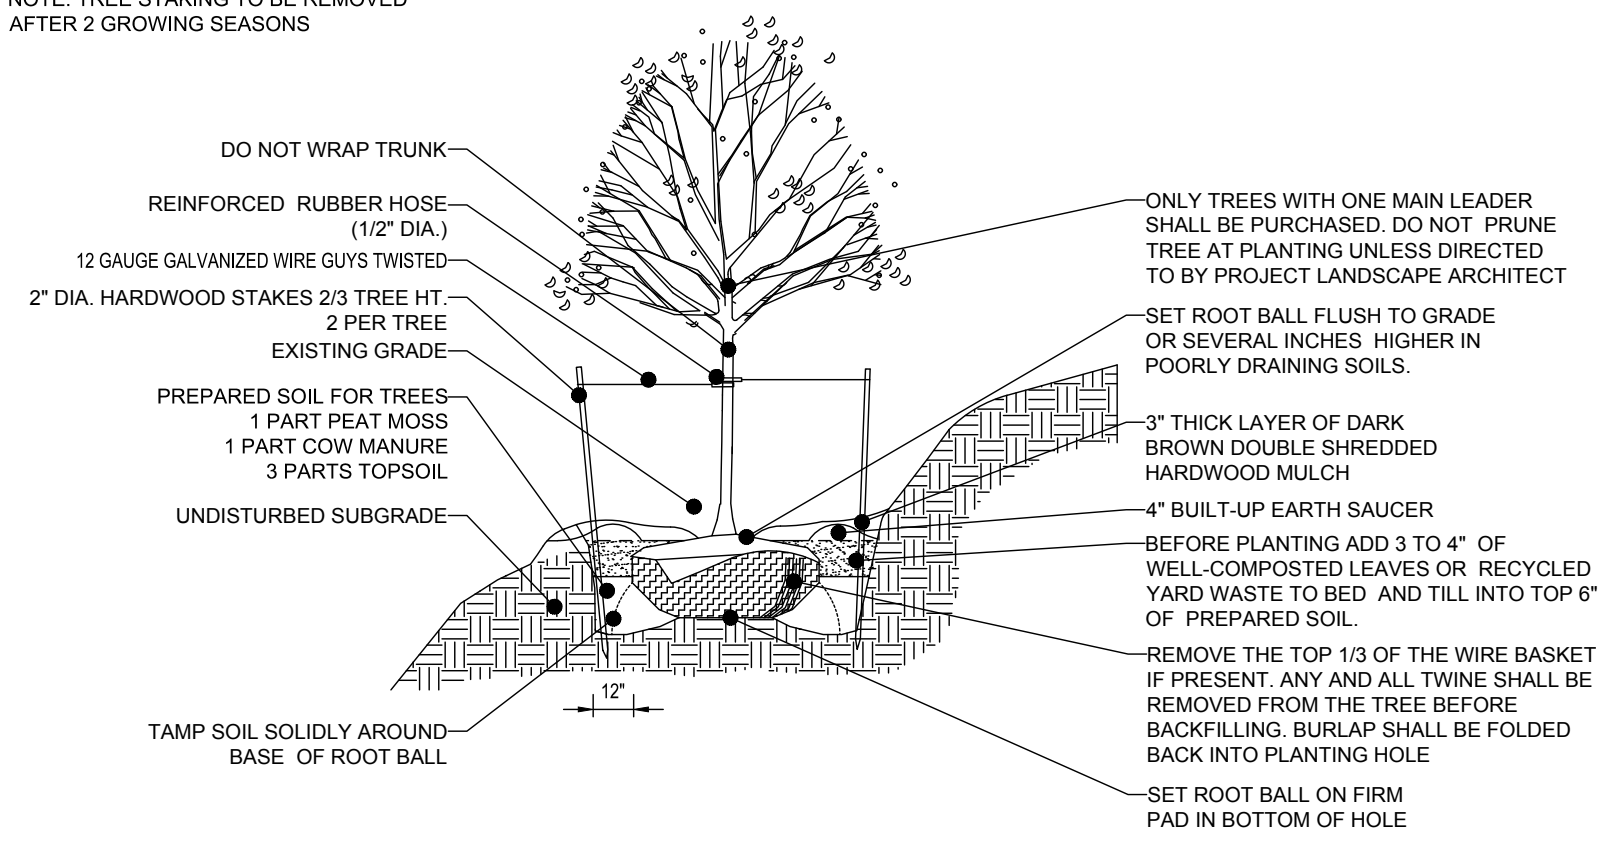
TYPICAL PERENNIAL AND GROUND COVER PLANTING



PERENNIAL/GROUND COVER PLANTING DETAIL

NOT TO SCALE

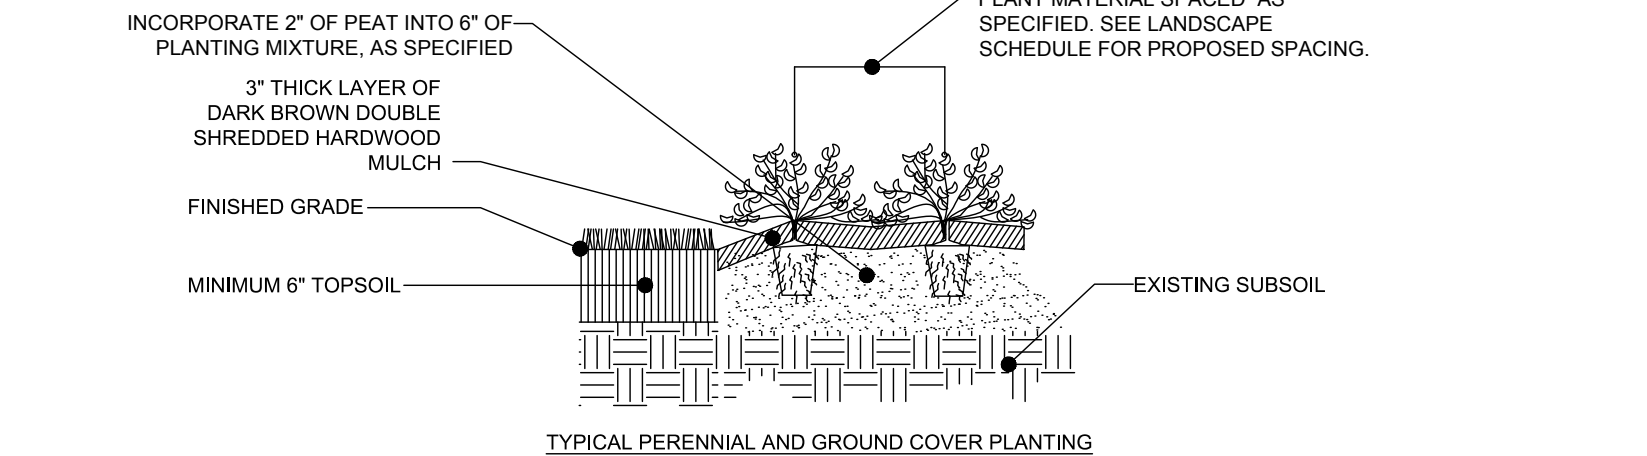NOTE: TREE STAKING TO BE REMOVED AFTER 2 GROWING SEASONS



TREE PLANTING ON SLOPE DETAIL

NOT TO SCALE

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3	12/19/19	HILLSBOROUGH COMMENTS	RMG	WES
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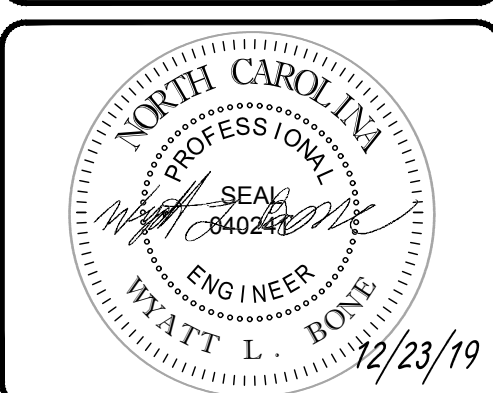
PROJECT: SITE PLAN REVIEW DOCUMENTS FOR



PROPOSED DEVELOPMENT
HAMPTON POINTE BLVD
ORANGE COUNTY
HILLSBOROUGH, NC

BOHLER
ENGINEERING NC, PLLC
NCBS P-1132

4130 PARKLAKE AVENUE, SUITE 130
RALEIGH, NC 27612
Phone: (919) 578-9000
NC@BohlerEng.com




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LANDSCAPE DETAILS

SHEET NUMBER:
C-900


REVISION 4 - 12/23/19

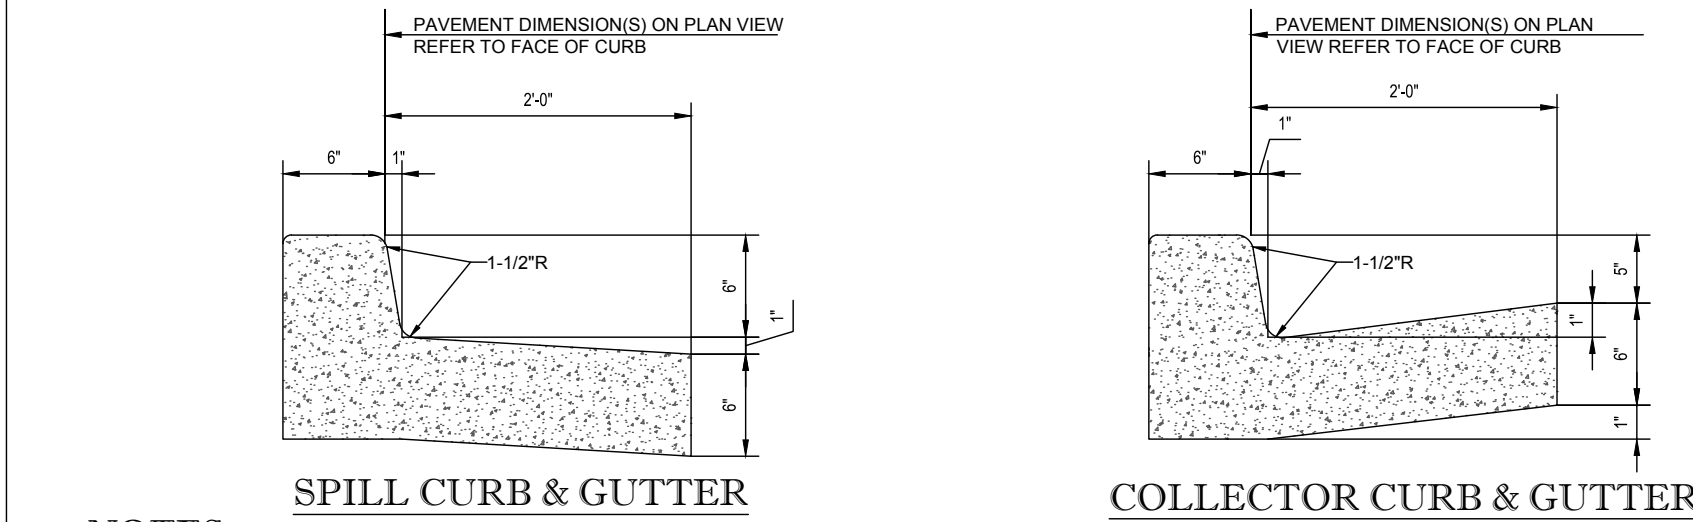

- NOTES:**
- CONCRETE FOR CURBING SHALL HAVE A MINIMUM COMPRESSIVE STRENGTH OF 3,000 P.S.I. @ 28 DAYS.
 - CONSTRUCTION STAKING FOR CURB INSTALLATION SHALL BE REFERENCED (CUT OR FILL) TO THE TOP OF CURB.
 - AT CONTRACTOR'S OPTION, THE GUTTER THICKNESS MAY BE INCREASED AT THE EDGE OF PAVEMENT TO MAKE BOTTOM OF GUTTER CONTIGUOUS WITH BOTTOM OF ASPHALT PAVEMENT.
 - CONTRACTION JOINTS SHALL BE PLACED @ 10'-0" O.C. TOOLED 1/4" (x1/16") WIDE. 1" DEEP. EXPANSION JOINTS SHALL BE PLACED @ 40'-0" INTERVALS, MAXIMUM, AND ALL P.C.'S.
 - GUTTER PAN SLOPE TO BE ADJUSTED WITHIN ACCESSIBLE PARKING SPACES TO MATCH SLOPE BETWEEN SPOT ELEVATIONS.

CONCRETE CURB & GUTTER DETAIL


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- NOTE:**
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STANDARD DUTY ASPHALT PAVEMENT SECTION

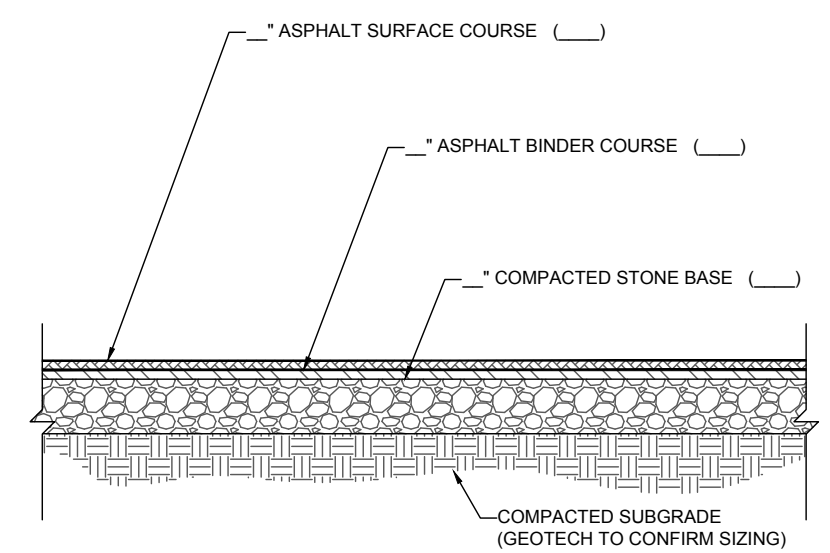NOT TO SCALE




- NOTE:**
- SECTION SHOWN IS BASED ON AN ANTICIPATED CBR OF ____ PER GEOTECHNICAL REPORT PREPARED BY ____ ENTITLED ____ DATED ____ (PROJECT # ____). FINAL DESIGN TO BE PROVIDED ONCE FINAL CBR'S ARE AVAILABLE ON COMPACTED SUB-BASE.

HEAVY DUTY ASPHALT PAVEMENT SECTION
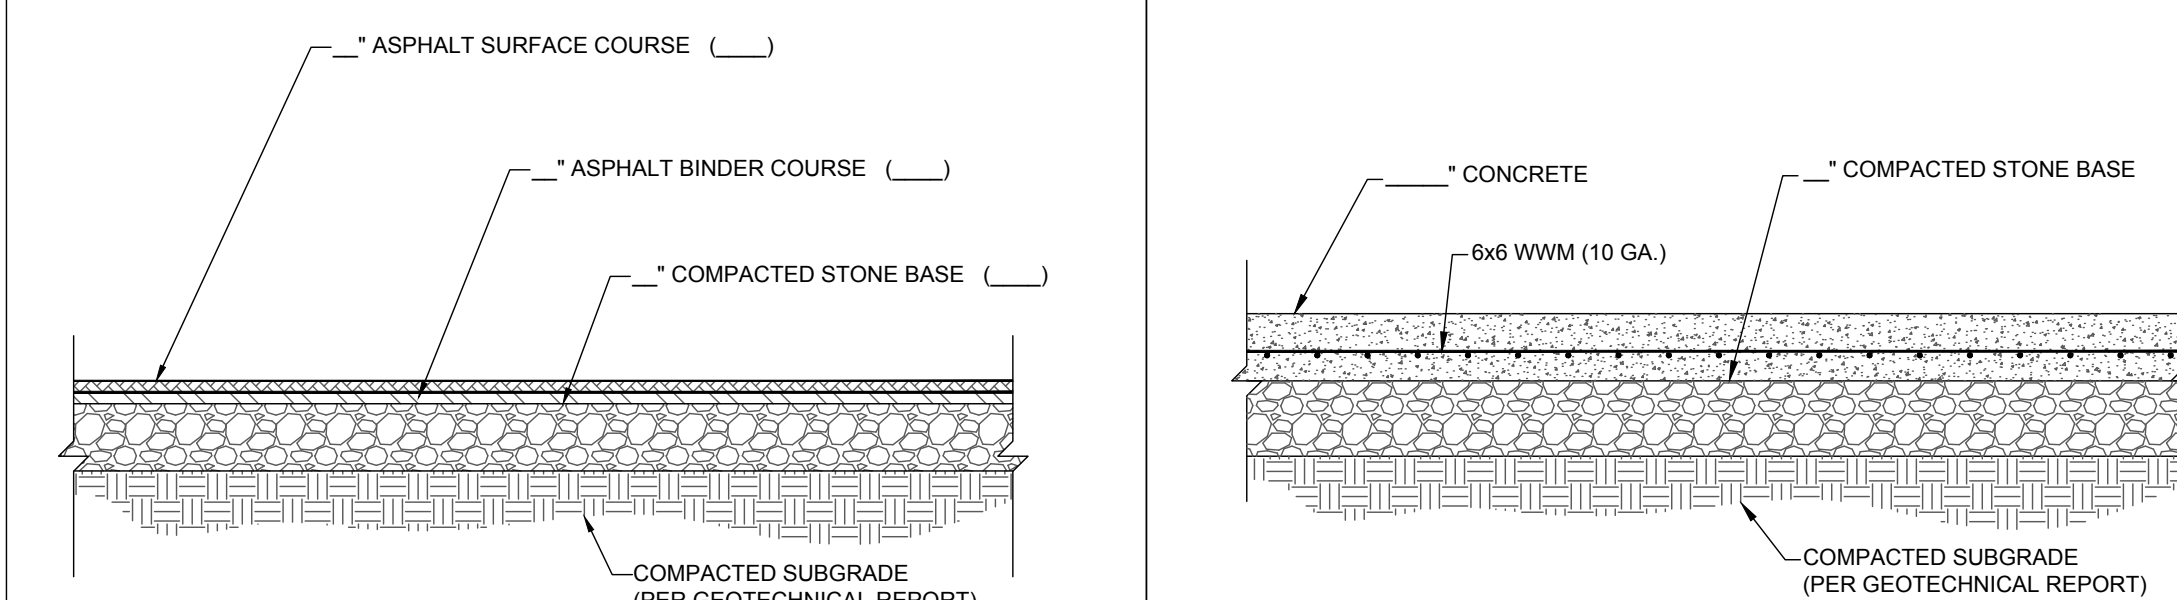
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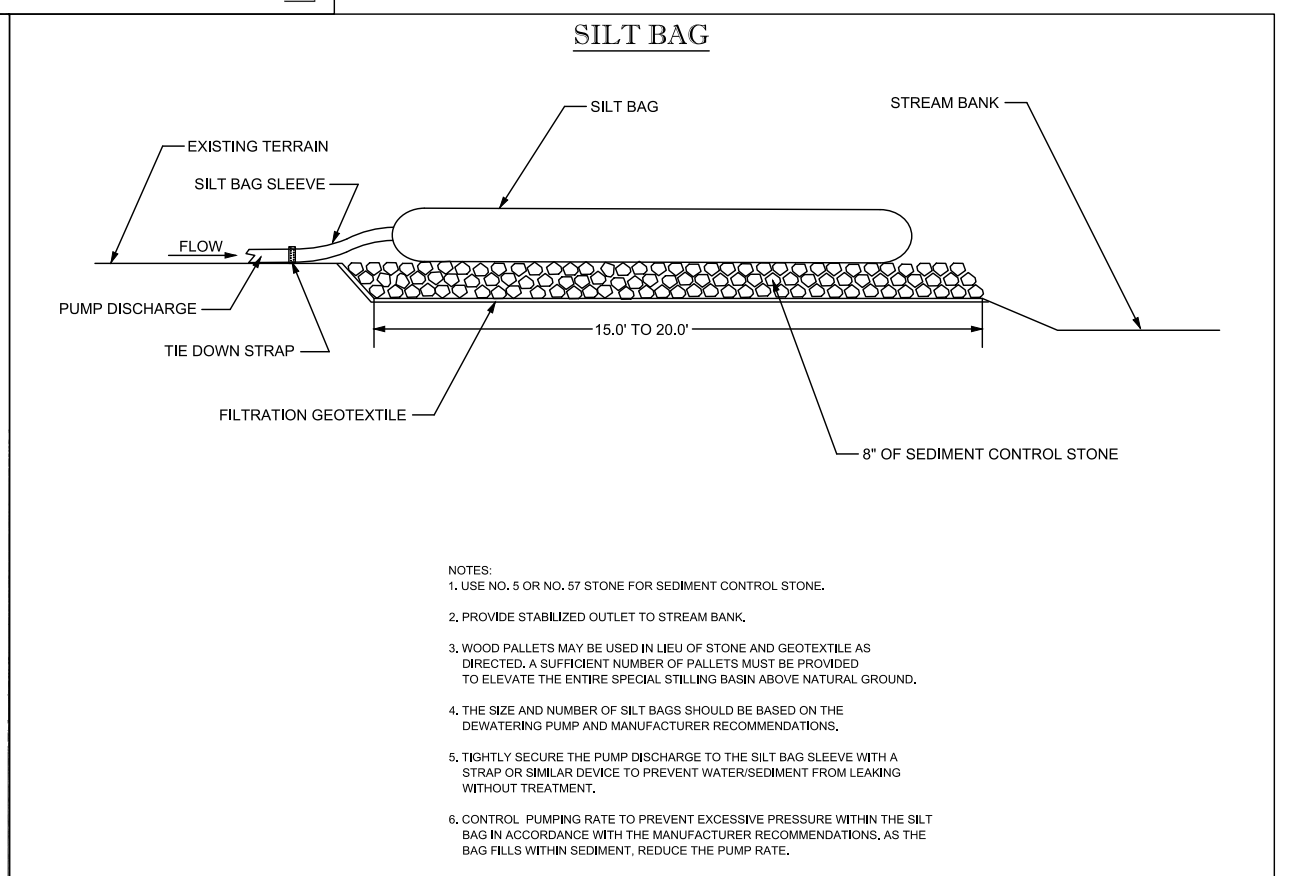
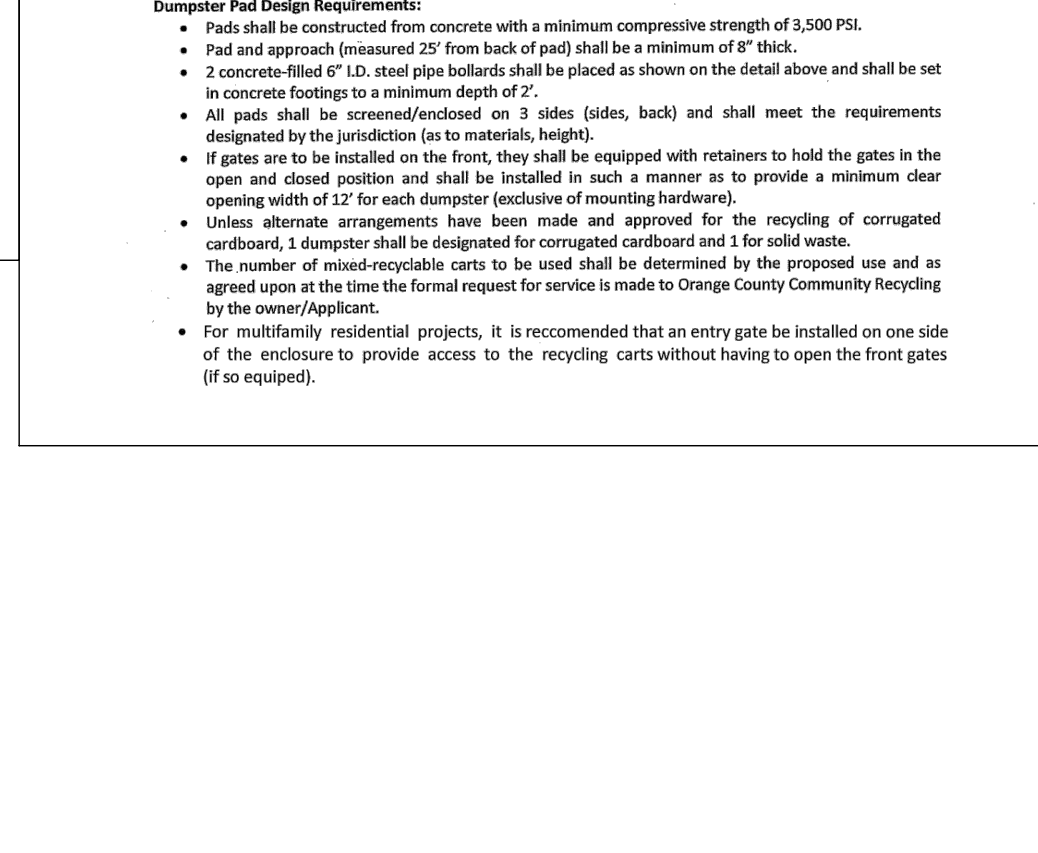
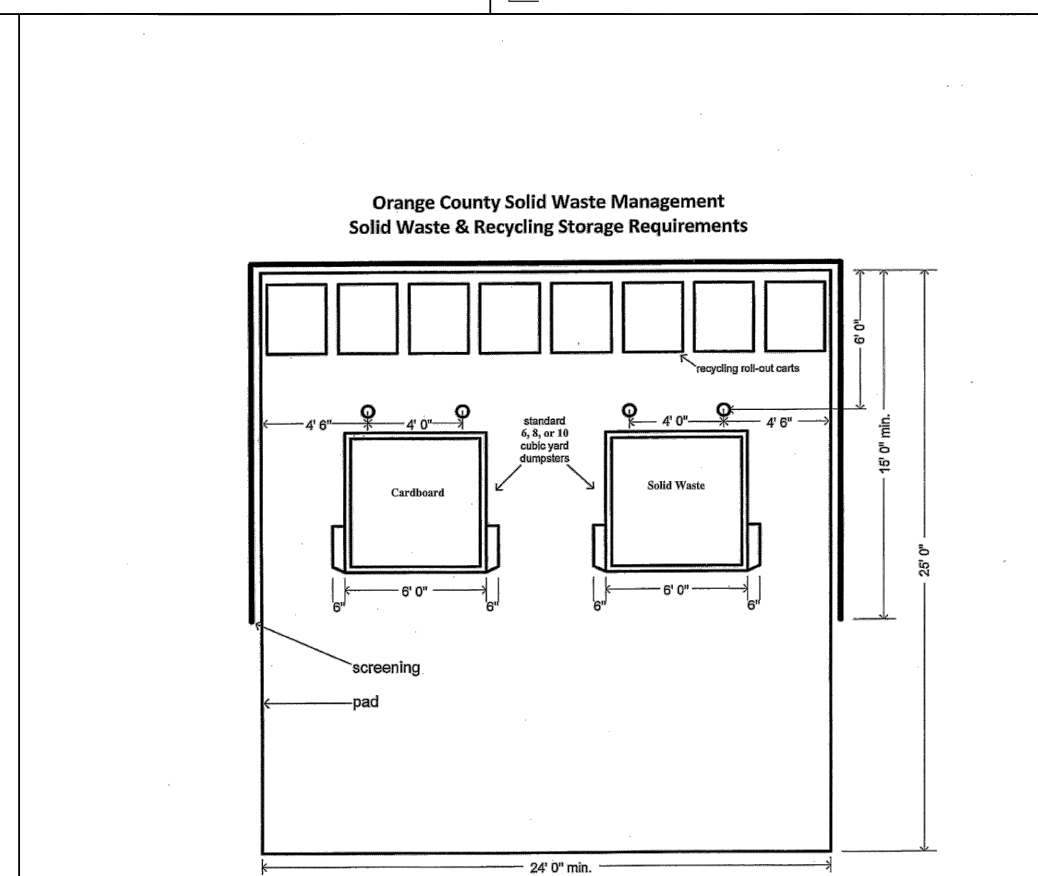
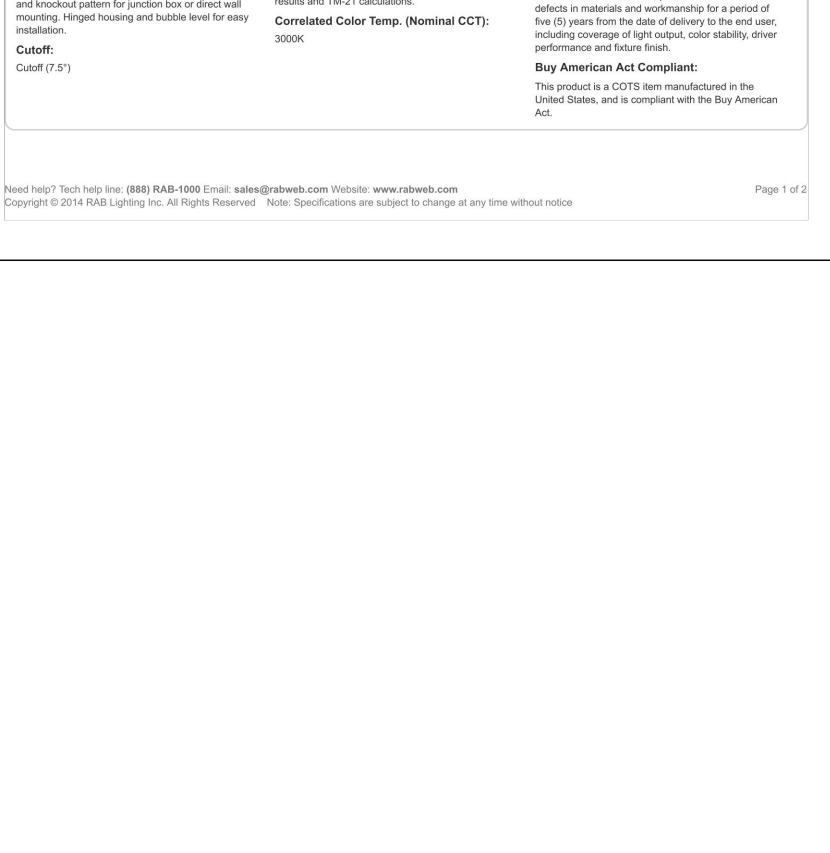
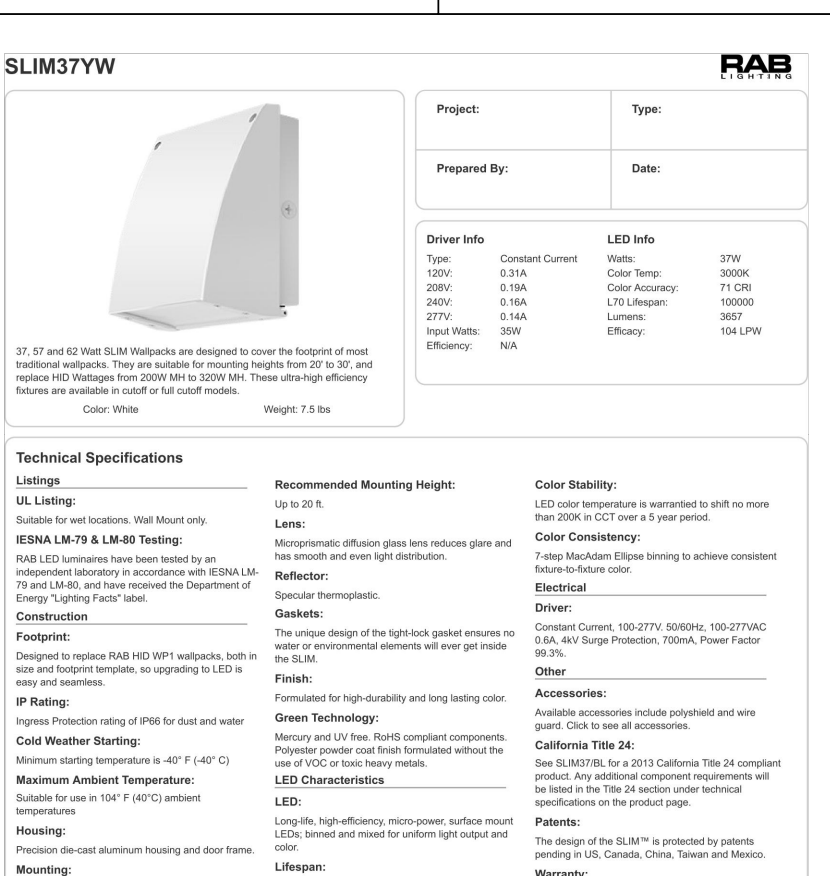
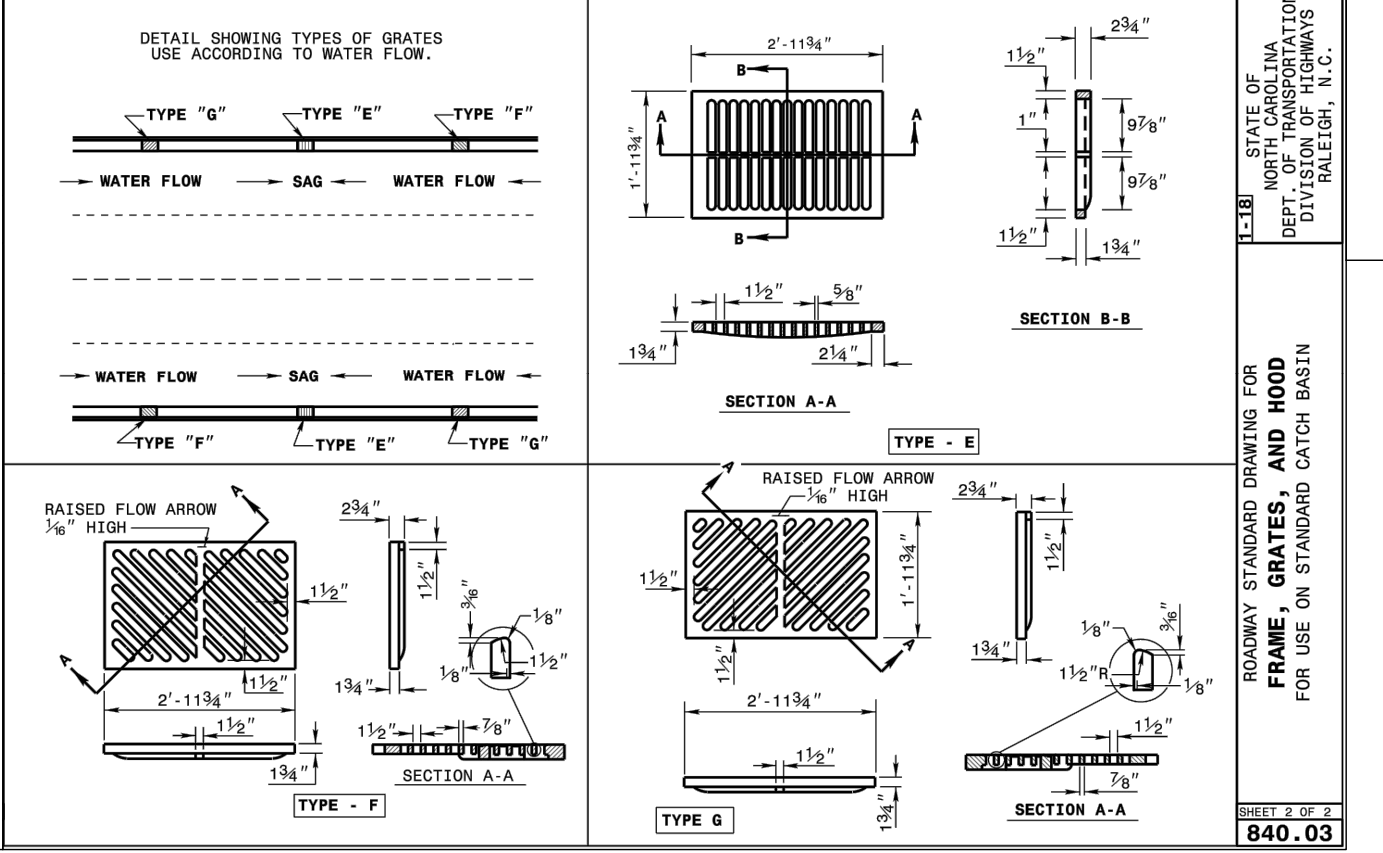
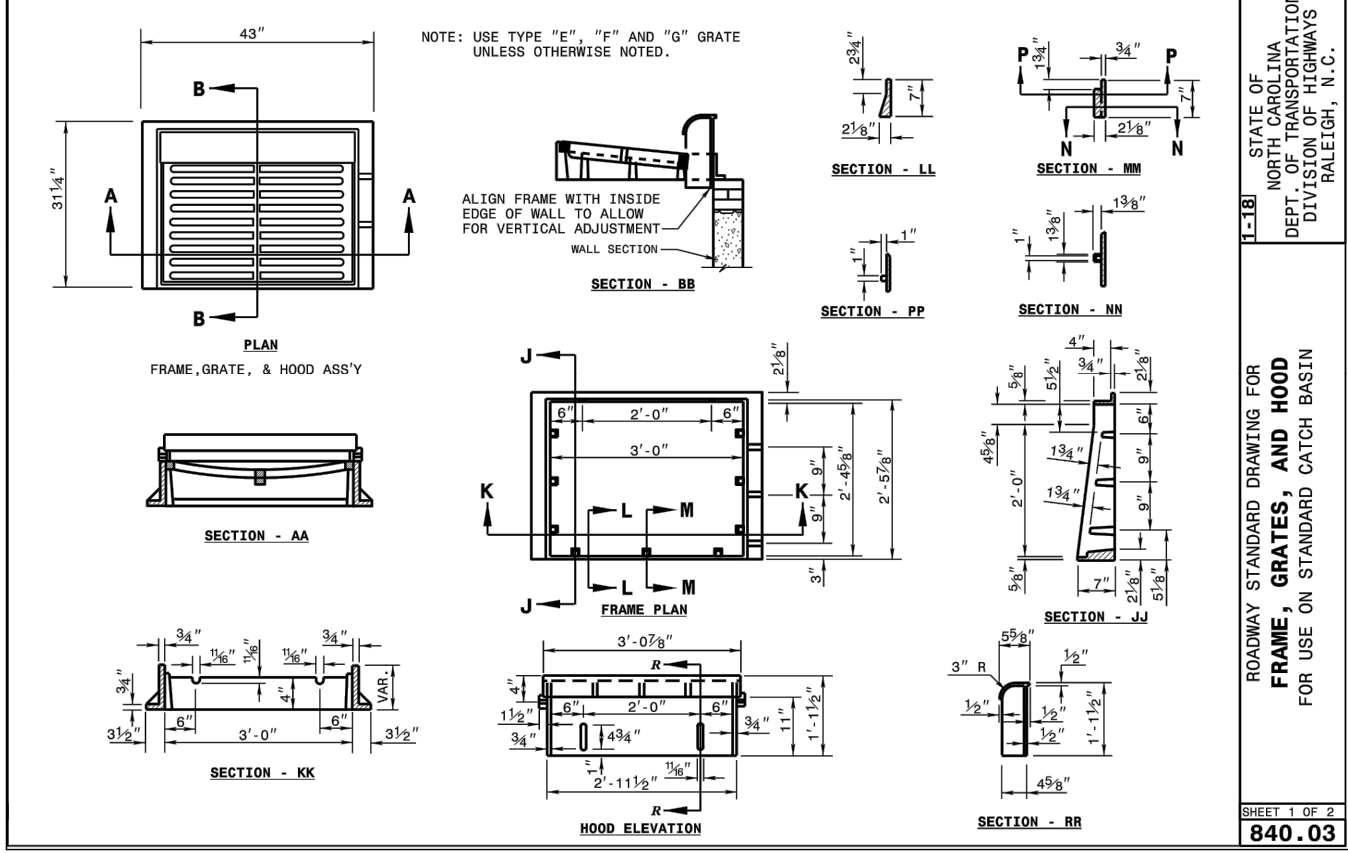
STANDARD DUTY CONCRETE SECTION

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MINIMUM DIMENSIONS AND QUANTITIES FOR CONCRETE CATCH BASINS

PIPE SIZE	MIN. WIDTH	MIN. DEPTH	MIN. LENGTH	MIN. CURB HEIGHT	MIN. GUTTER HEIGHT	MIN. REINFORCEMENT	MIN. CONCRETE STRENGTH
12"	12'-0"	18"-0"	12'-0"	18"-0"	18"-0"	6x6 WWM (10 GA.)	3,000 P.S.I.
18"	18'-0"	24"-0"	18'-0"	24"-0"	24"-0"	6x6 WWM (10 GA.)	3,000 P.S.I.
24"	24'-0"	30"-0"	24'-0"	30"-0"	30"-0"	6x6 WWM (10 GA.)	3,000 P.S.I.
30"	30'-0"	36"-0"	30'-0"	36"-0"	36"-0"	6x6 WWM (10 GA.)	3,000 P.S.I.
36"	36'-0"	42"-0"	36'-0"	42"-0"	42"-0"	6x6 WWM (10 GA.)	3,000 P.S.I.
42"	42'-0"	48"-0"	42'-0"	48"-0"	48"-0"	6x6 WWM (10 GA.)	3,000 P.S.I.
48"	48'-0"	54"-0"	48'-0"	54"-0"	54"-0"	6x6 WWM (10 GA.)	3,000 P.S.I.
54"	54'-0"	60"-0"	54'-0"	60"-0"	60"-0"	6x6 WWM (10 GA.)	3,000 P.S.I.

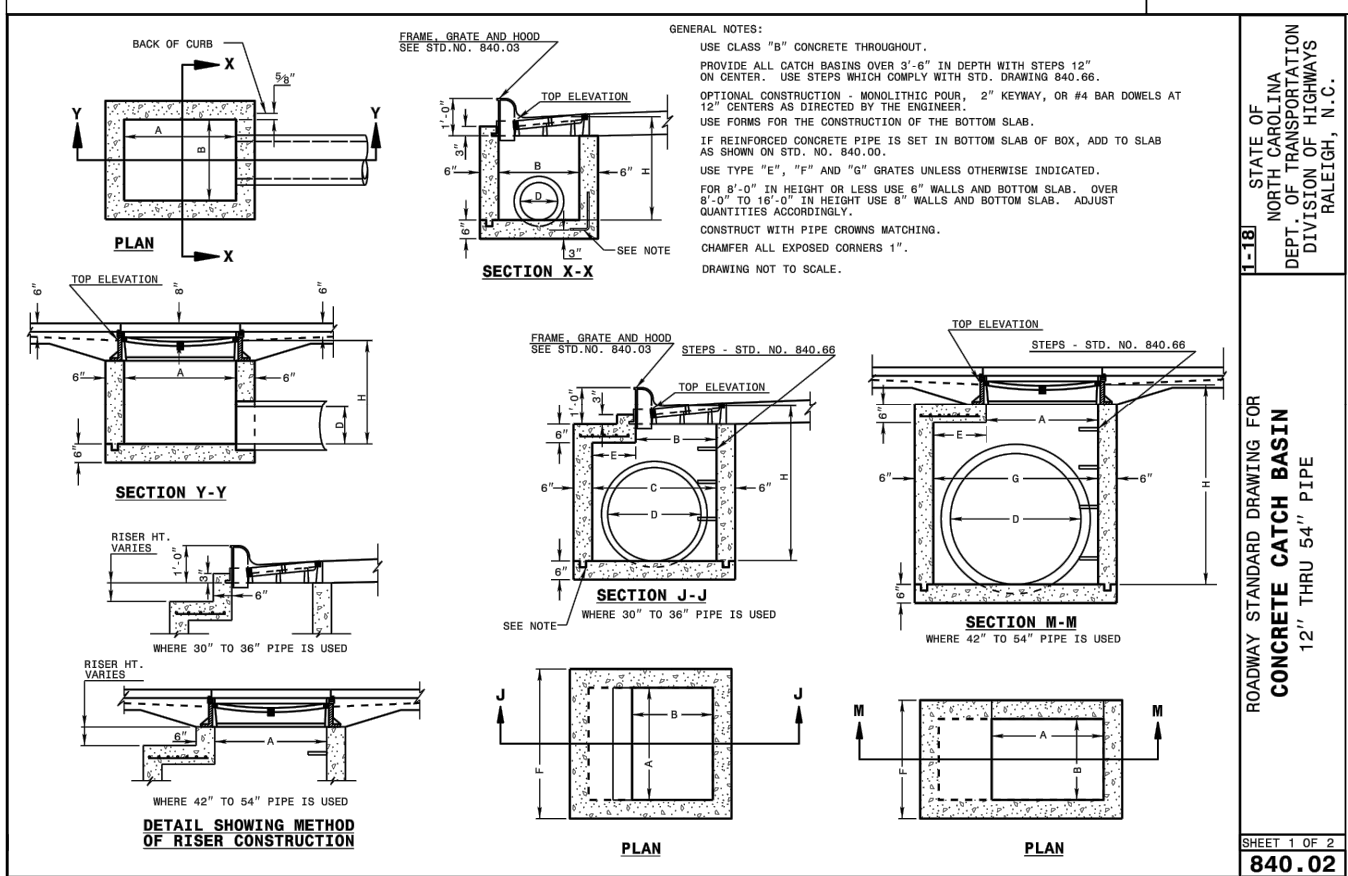

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PROPOSED DEVELOPMENT

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ORANGE COUNTY

HILLSBOROUGH, NC

MAVIS DISCOUNT TIRE

BOHLER

ENGINEERING NC, PLLC

4130 PARKLAKE AVENUE, SUITE 130

RALEIGH, NC 27612

Phone: (919) 578-9000

NC@BohlerEng.com

NORTH CAROLINA

PROFESSIONAL

SEAL

44024

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WATT L. BONE

12/23/19

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SHEET NUMBER:

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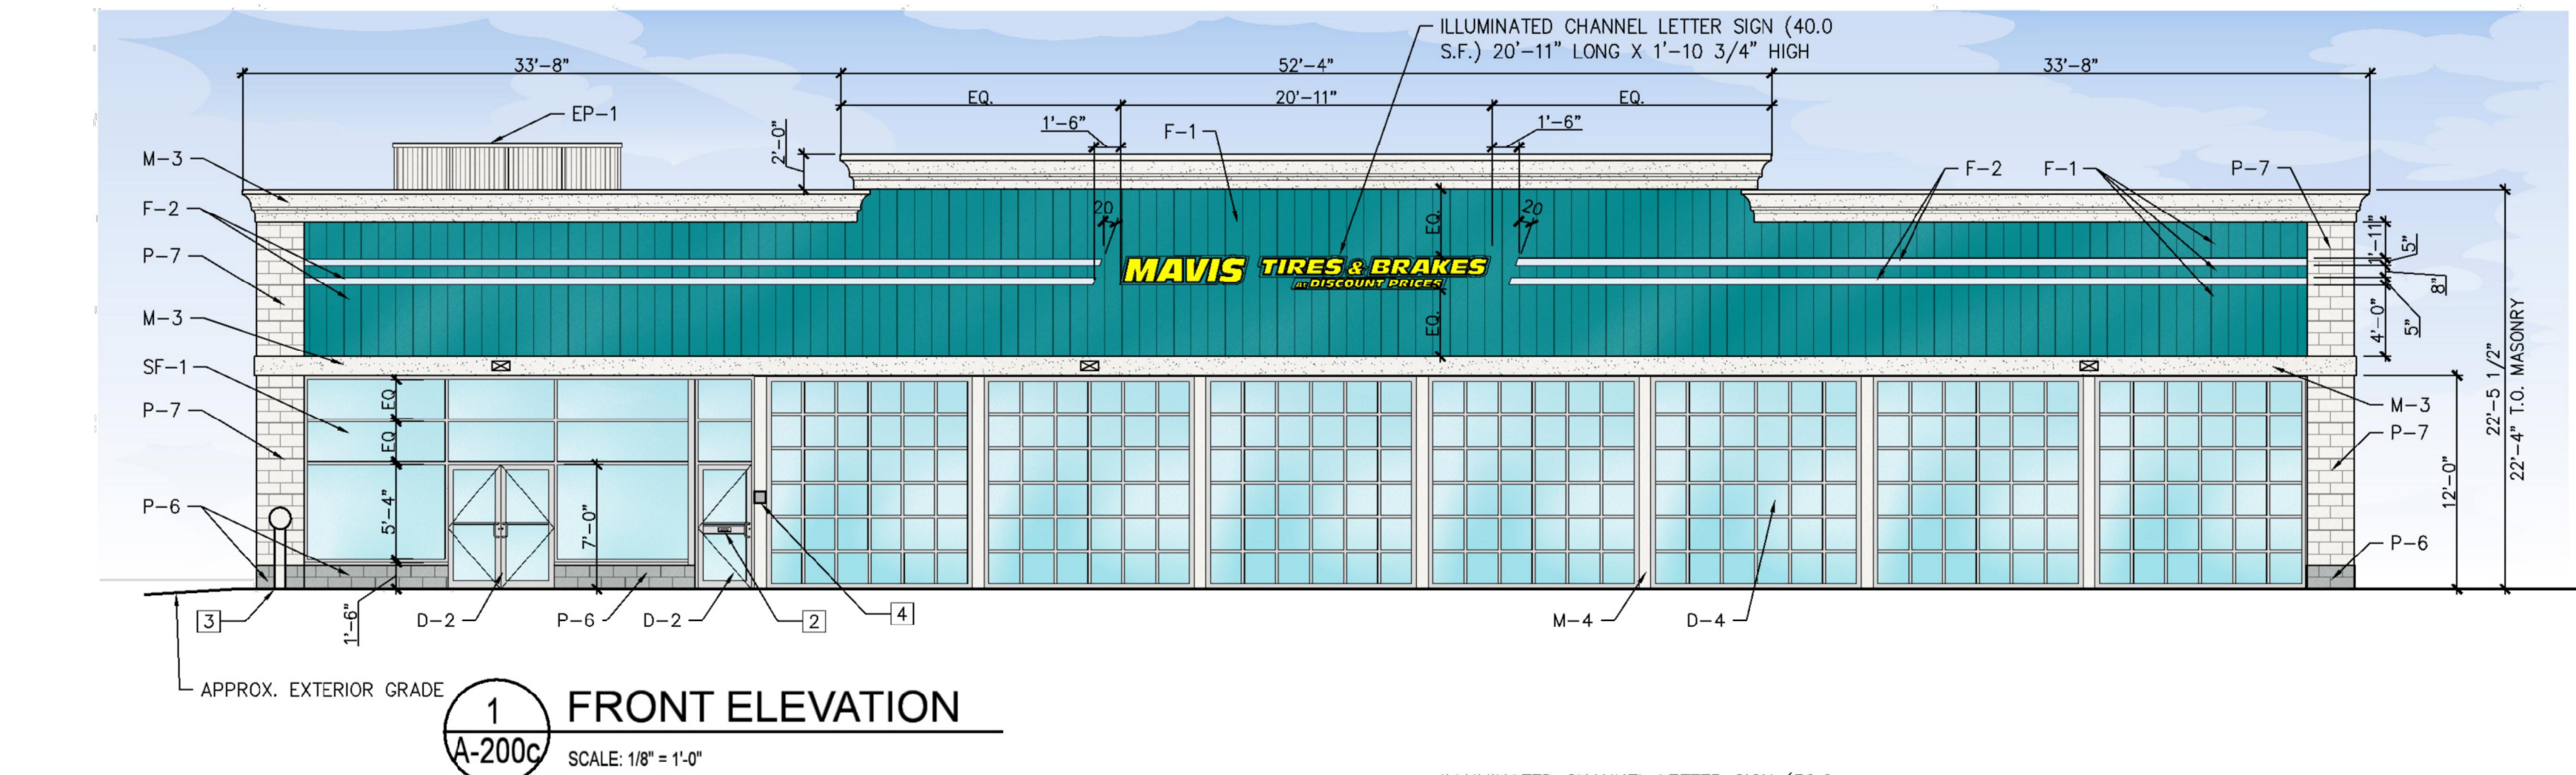
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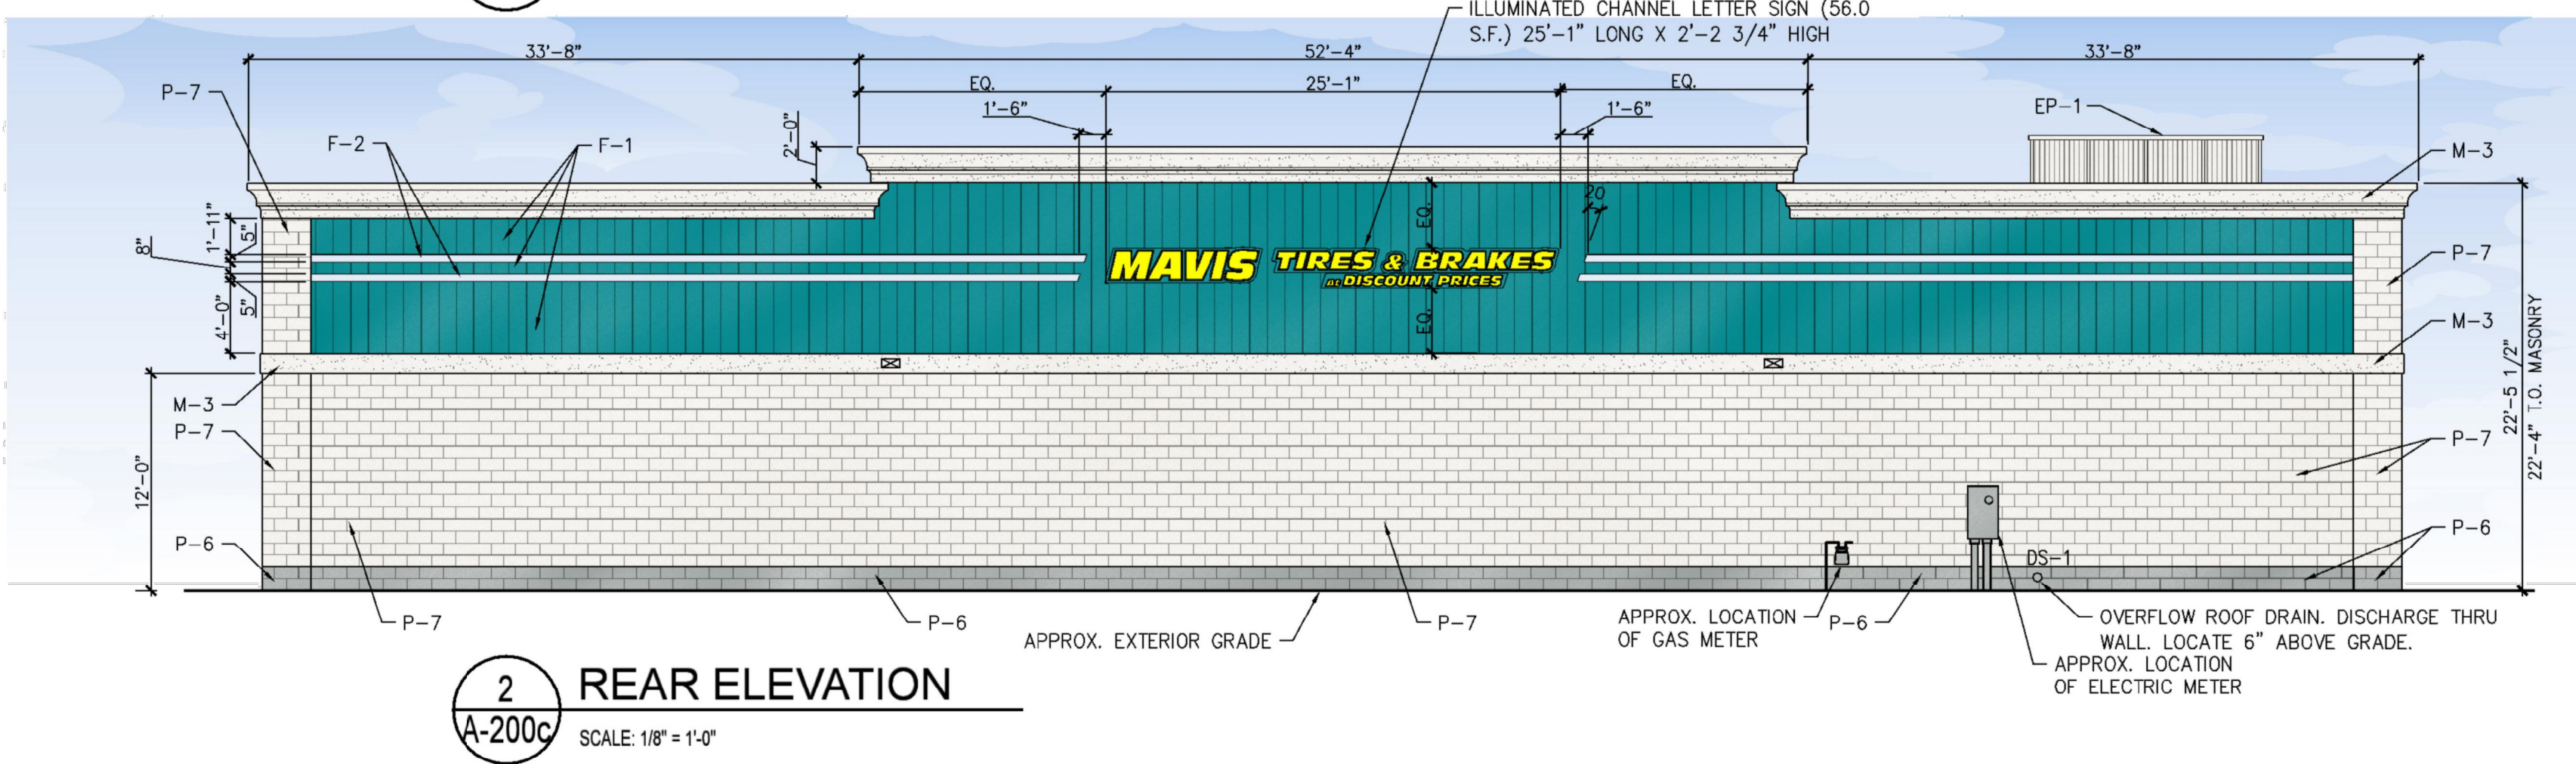
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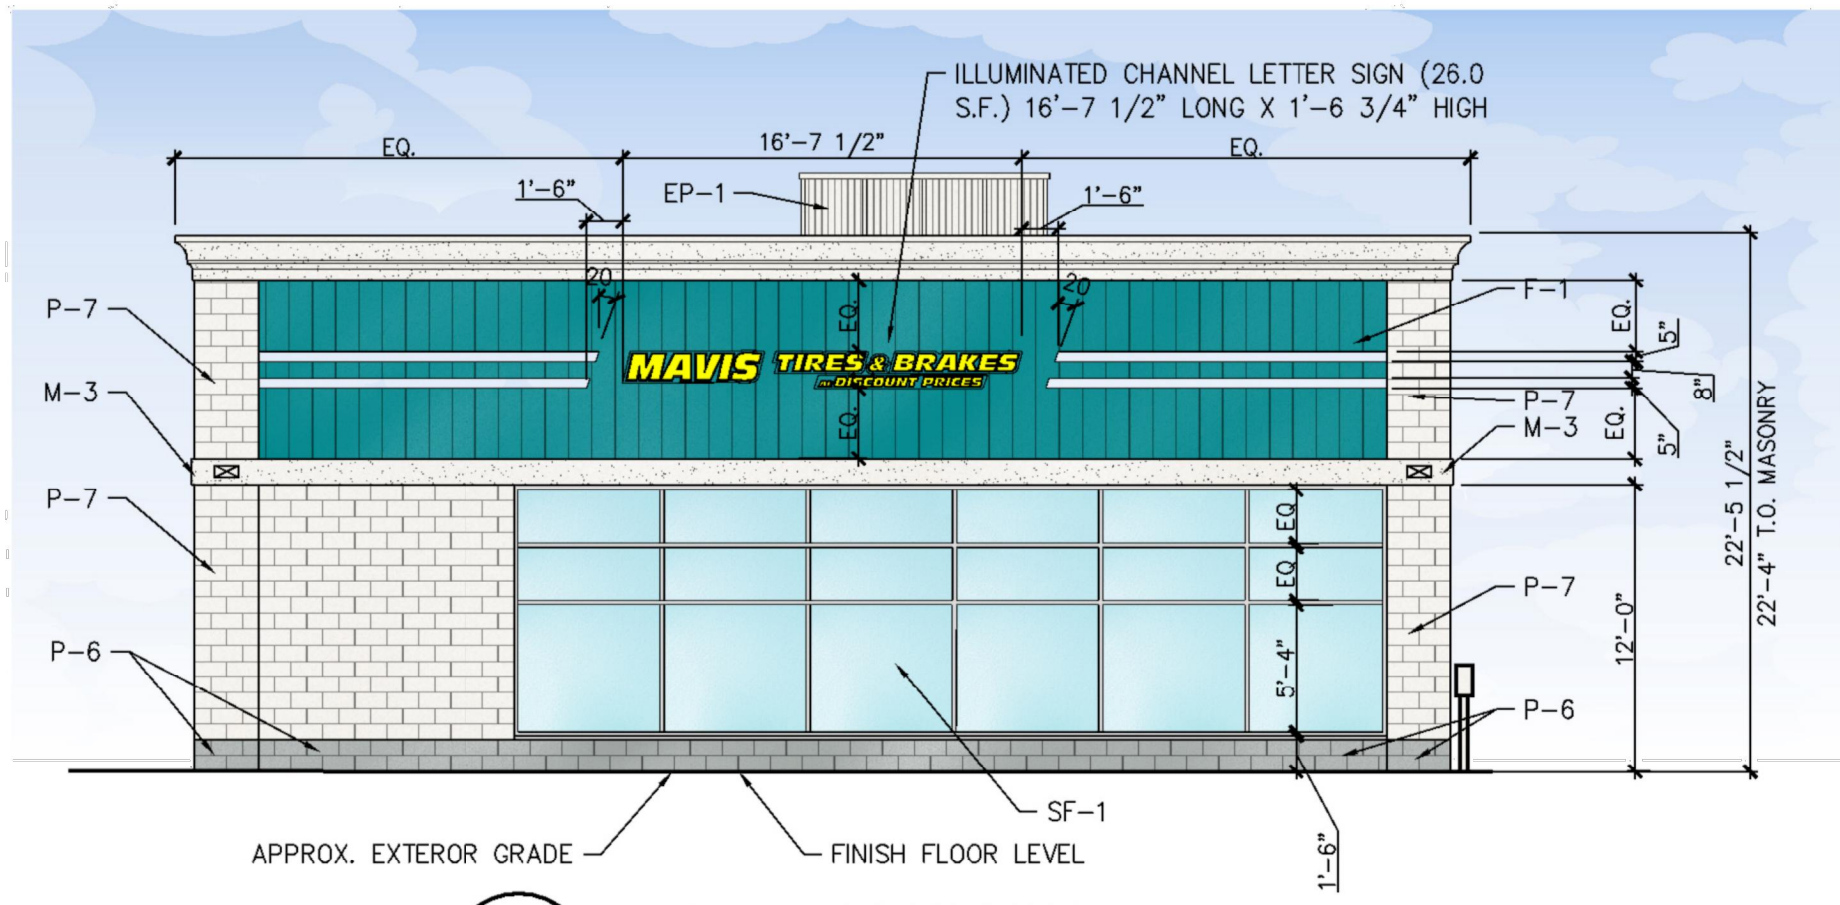





1 FRONT ELEVATION
A-200c
SCALE: 1/8" = 1'-0"



2 REAR ELEVATION
A-200c
SCALE: 1/8" = 1'-0"



3 LEFT ELEVATION
A-200c
SCALE: 1/8" = 1'-0"

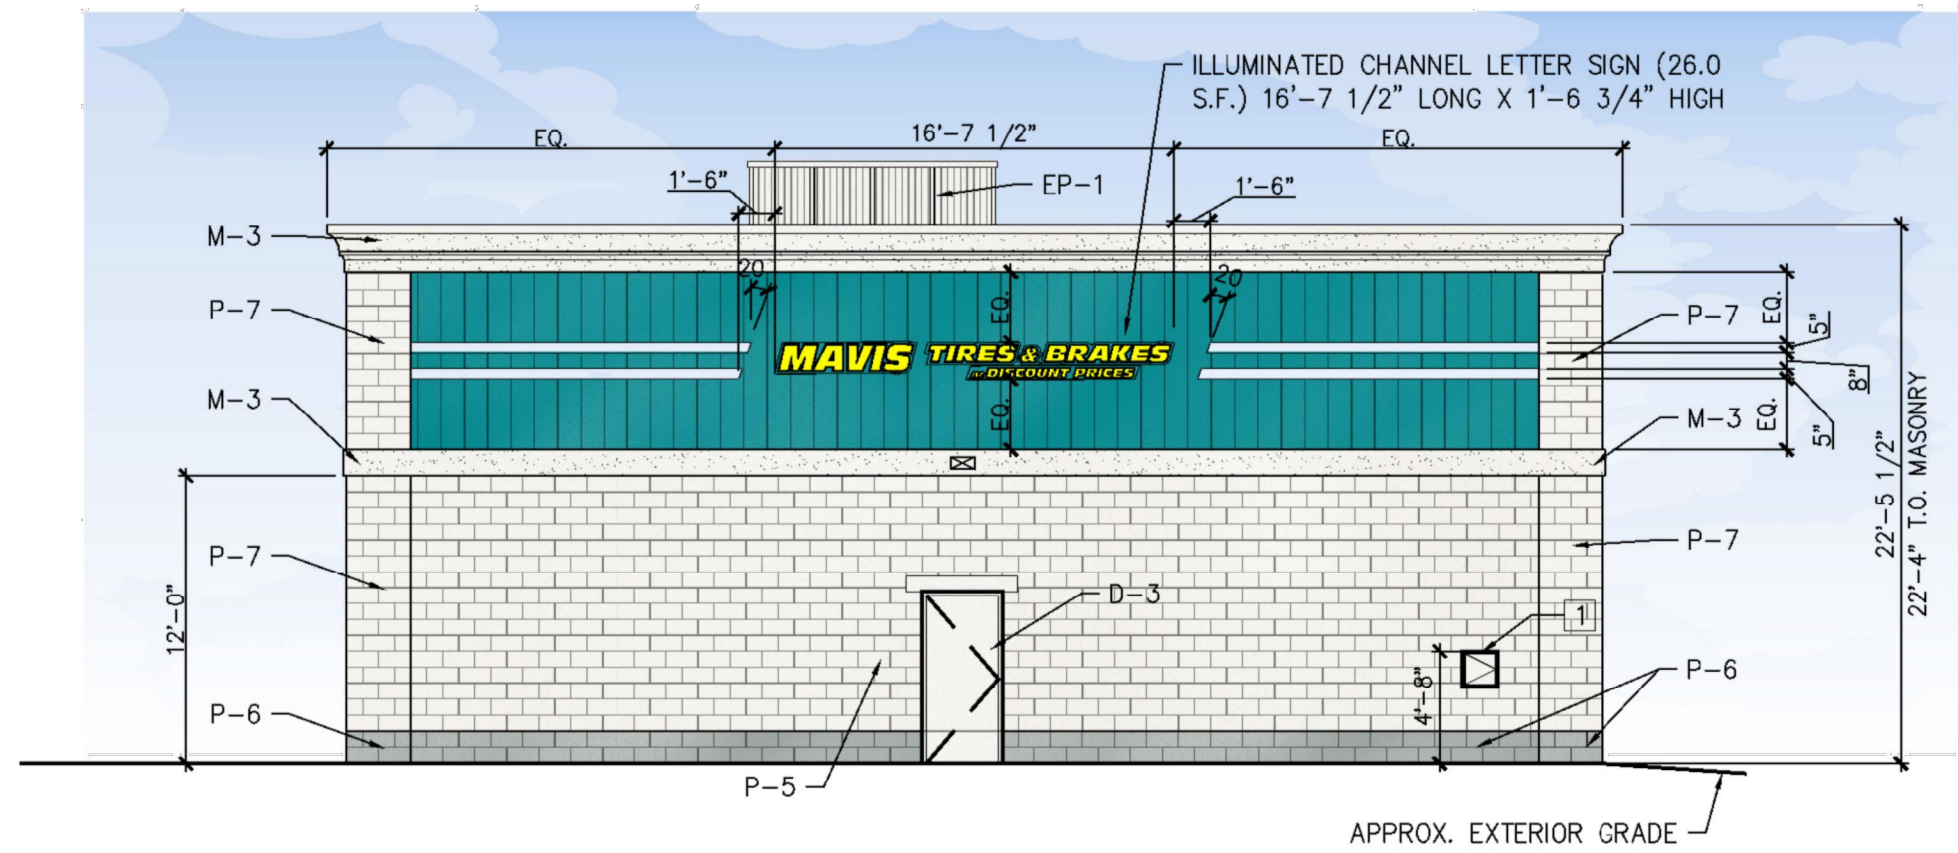

4 RIGHT ELEVATION
A-200c
SCALE: 1/8" = 1'-0"

EXTERIOR MATERIALS SCHEDULE

MARK	MATERIAL	MANUFACTURER	STYLE/COLOR	NOTES
DOOR FINISHES	D-2	ALUMINUM STOREFRONT DOOR & FRAME	KAWNEER	COLOR: CLEAR ANODIZED ALUMINUM INSTALL PER MFR RECOMMENDATIONS.
	D-3	PAINT FOR GALVANIZED HM DOOR & FRAME	BENJAMIN MOORE	COLOR: OC-129 ALABASTER WHITE SHEEN: SEMI-GLOSS FINISH PER MFR RECOMMENDATIONS. PRIMER: (1) COAT- BM SUPER SPEC HP ACRYLIC PRIMER #HP04 FINISH COAT: (2) COATS- BM SUPER SPEC HP D.T.M. ACRYLIC SEMI-GLOSS #HP29
	D-4	ALUMINUM AND GLASS OH DOORS	CLOPAY BUILDING PRODUCTS COMPANY	CLOPAY MODEL 903 COLOR: CLEAR SATIN ANODIZED ALUMINUM INSTALL PER MFR RECOMMENDATIONS. RE: SPECS FOR ADDITIONAL INFO.
MISC. ITEMS	F-1	VERTICAL METAL FASCIA	ATAS	MULTIPURPOSE PANELS- MPN SEMI STANDING SEAM 12" WIDE, 0.032" ALUMINUM COLOR: #19 TEAL INSTALL PER MFR RECOMMENDATIONS.
	F-2	ALUMINUM ACCENT STRIPE	ATAS	0.032" ALUMINUM COLOR: #26 BONE WHITE INSTALL PER MFR RECOMMENDATIONS.
	F-3	METAL ROOF COPING	ROOF MFR	MATCH ROOF SYSTEM COLOR: MATCH ALABASTER WHITE INSTALL PER MFR RECOMMENDATIONS.
	M-3	EIFS CORNICE & BAND	DRYVIT OR APPROVED EQUAL	COLOR: #101 SUPER WHITE INSTALL PER MFR RECOMMENDATIONS.
	M-4	PAINT FOR STEEL LINTELS & COLUMNS	BENJAMIN MOORE	COLOR: OC-129 ALABASTER WHITE SHEEN: LOW LUSTRE FINISH PER MFR RECOMMENDATIONS. PRIMER: (1) COAT- BM SUPER SPEC HP ACRYLIC PRIMER #HP04 FINISH COAT: (2) COATS- BM SUPER SPEC HP D.T.M. ACRYLIC LOW LUSTRE #HP25
WALL FINISHES	P-5	PAINTED CONCRETE BLOCK	BENJAMIN MOORE	COLOR: OC-129 ALABASTER WHITE SHEEN: LOW LUSTRE FINISH AND INSTALL PER MFR RECOMMENDATIONS. PRIMER: (1) COAT- BM ULTRA SPEC MASONRY HI-BUILD BLOCK FILLER 571 FINISH COAT: (2) COATS- BM ULTRA SPEC ELASTOMERIC LOW LUSTRE 360
	P-6	PAINTED SPLIT FACE BLOCK	BENJAMIN MOORE	COLOR: HC-164 PURITAN GRAY SHEEN: LOW LUSTRE FINISH AND INSTALL PER MFR RECOMMENDATIONS. PRIMER: (1) COAT- BM ULTRA SPEC MASONRY HI-BUILD BLOCK FILLER 571 FINISH COAT: (2) COATS- BM ULTRA SPEC ELASTOMERIC LOW LUSTRE 360
	P-7	PAINTED SPLIT FACE BLOCK	BENJAMIN MOORE	COLOR: OC-129 ALABASTER WHITE SHEEN: LOW LUSTRE FINISH AND INSTALL PER MFR RECOMMENDATIONS. PRIMER: (1) COAT- BM ULTRA SPEC MASONRY HI-BUILD BLOCK FILLER 571 FINISH COAT: (2) COATS- BM ULTRA SPEC ELASTOMERIC LOW LUSTRE 360
	SF-1	ALUMINUM STOREFRONT SYTEM	KAWNEER	COLOR: CLEAR ANODIZED ALUMINUM INSTALL PER MFR RECOMMENDATIONS. INSTALL WITH 1" LOW-E INSULATED GLAZING. MAX U-FACTOR: U-0.32 MAX SHGC: 0.40
	EP-1	ENVISOR PANEL RTU SCREEN	CITYSCAPES	COLOR: ALABASTER STYLE: VERTICAL 7.2 RIB METAL TRIM STYLE: BAND INSTALL PER MFR RECOMMENDATIONS.


GENERAL NOTES:
A. ALL FINISHES ON MATERIAL SCHEDULE MAY NOT BE USED
B. CENTER WALL LIGHTS OVER COLUMNS, DOORS & WINDOWS, ETC., AS SHOWN U.O.N.
C. MOUNTING HEIGHT OF EXTERIOR LIGHT FIXTURE ON REAR AND SIDE ELEVATIONS TO MATCH MOUNTING HEIGHT OF LIGHT FIXTURES ON FRONT ELEVATION
D. REFER TO SHEET A-800 FOR INFO REGARDING ILLUMINATED CHANNEL LETTER SIGNS.

EXTERIOR ELEVATION KEYNOTES

1	16"x16" INSULATED ALUMINUM ACCESS DOOR BY BEST ACCESS DOORS. SKU # BA-PAL-16-16. FINAL COLOR SELECTION TO BE APPROVED BY OWNER AND ARCHITECT. RE: DETAIL 7/A-502 FOR ADDITIONAL INFO. (ACCESS DOOR IS FOR USE TO ACCESS OIL TANKS. COORDINATE FINAL LOCATION WITH TANK INSTALLER)
2	PROVIDE KEY DROP SLOT IN GARAGE ENTRY DOOR. FINAL INSTALLATION LOCATION TO BE DIRECTED BY MAVIS.
3	FREESTANDING AIR INFLATOR. LOCATION TO BE SITE SPECIFIC. (RE: RESPONSIBILITY SCHEDULE FOR ADDITIONAL INFO.)
4	PROVIDE KNOX BOX WHERE REQUIRED BY JURISDICTION (PURCHASED FROM LOCAL FIRE DEPARTMENT.) MOUNT PER FIRE DEPARTMENT REQUIREMENTS ON WALL ADJACENT TO ENTRANCE. CONTRACTOR TO MAKE APPLICATION FOR KNOX BOX AND COORDINATE WITH LOCAL APPROVING AUTHORITY.




ARCHITECT
THE LARSON ARCHITECTURAL GROUP, INC.
1000 COMMERCE PARK DRIVE
SUITE 201
WILLIAMSPORT, PA 17701
PHONE: (570) 323-6603
ROBERT GEHR, AIA
PRIMARY CONTACT: KRISTEN BRULE

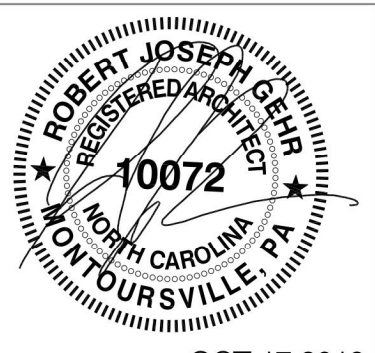

OCT 17 2019

ISSUED FOR TRC RESUBMISSION	COMMENTS	BY	CHKD
10/16/19	DATE	NO	

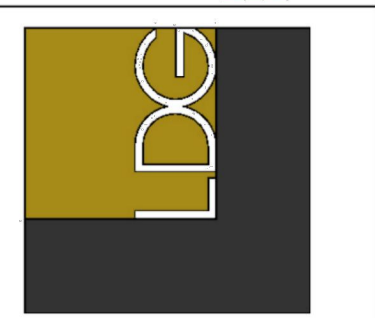

EXTERIOR ELEVATIONS
MAVIS DISCOUNT TIRE #391 - HILSBOROUGH, NC
Larson Design Group - Architects Engineers Surveyors
1000 Commerce Park Drive - Suite 201
Williamsport, PA 17701
PHONE 570.323.6603 TOLL FREE 877.323.6603
FAX 570.323.9902 www.larsondesigngroup.com
MAVIS TIRE SUPPLY, LLC
358 SAW MILL RIVER ROAD
MILLWOOD, NY 10546
PHONE (914) 984-2500

SHEET NO.: A-200c

PROJECT NO.: 11432-042